

Staff Report

Infill Housing Design Review Committee

File Number: 4-D-24-IH

Meeting: 4/17/2024

Applicant: Christopher Smith **Owner:** Christopher Smith

Property Information

Location: 3221 Bellevue St. **Parcel ID** 70 P A 05201

Zoning: RN-2 (Single-Family Residential Neighborhood) **District:** Edgewood Park Infill Housing Overlay District

Description of Work

Level III New Primary Structure

New primary structure fronting Bellevue Street. One-and-one-half story residence features a side-gable roof (10/12 pitch, with a 6/12 pitch massing towards the rear), with a projecting front-gable roof massing on the right side. The house measures 30' wide by 35'-4" deep. The house features an entry recessed below a front-gable roof entry vestibule. Parking is located to the rear and accessed via Seymour Avenue.

The façade (east) features a projecting bay window with a multi-light window on the left bay with a small front-gable wall dormer above, a centrally located door below the entry vestibule, and a rounded window on the upper gable field. The right side (north) elevation features a projecting shed-roof massing clad in lap siding, with a steel panel roof. The left side (south) elevation features three bays of windows on the first bay and two on the gable field. Windows are depicted as multi-light casement windows.

Applicable Design Guidelines

Heart of Knoxville Infill Housing Design Guidelines

- 1. Front Yards
- Consistent front yard space should be created along the street with the setback of a new house matching the older houses on the block.
- A walkway should be provided from the sidewalk or street to the front door. Along grid streets, the walk should be perpendicular to the street.
- Healthy trees that are outside the building footprint should be preserved. The root area should be marked and protected during construction.
- 2. Housing Orientation
- New housing should be proportional to the dimensions of the lot and other houses on the block.
- On corner lots, side yard setbacks should be handled traditionally (that is, closer to the side street). The zoning requirement to treat corner lots as having two frontages should not apply in Heart of Knoxville neighborhoods.
- Side yard setbacks should be similar to older houses on the block, keeping the rhythm of spacing between houses consistent.

3. Alleys, Parking, and Services

- Parking should not be in front yards.
- Alley access should be used for garage or parking pad locations. On level ground, pea gravel or similar material may be used as a parking pad off alleys.
- Garages which are perpendicular to the alley should be about 18 feet from the center line of the alley pavement, allowing a comfortable turning radius for a driver to enter a garage.
- Alley-oriented parking pads, garbage collection points, and utility boxes should be screened with a combination of landscaping and fencing.
- On those streets which have alleys, driveways should not be permitted from the front of the house.
- On corner lots, a driveway to the garage may be provided off the side street.

4. Scale, Mass, and Foundation Height

- The front elevation should be designed to be similar in scale to other houses along the street.
- The front façade of new houses should be about the same width as original houses on the block.
- New foundations should be about the same height as the original houses in the neighborhood.
- If greater height is to be created (with new construction or an addition), that portion of the house should be located toward the side or rear of the property.

5. Porches and Stoops

- Porches should be part of the housing design in those neighborhoods where porches were commonplace.
- Porches should be proportional to original porches on the block, extending about 8-12 feet toward the street from the habitable portion of the house.
- Porches should extend into the front yard setback, if necessary, to maintain consistency with similarly sited porches along the street.
- Porch posts and railings should be like those used in the historic era of the neighborhood's development. Wrought iron columns and other materials that were not used in the early 1900's should not be used.
- Small stoops centered on entry and no more than 5 feet deep are appropriate on blocks where porches were not traditional.

6. Windows and Doors

- When constructing new houses, the window and door styles should be similar to the original or historic houses on the block.
- To respect the privacy of adjacent properties, consider the placement of side windows and doors.
- The windows and doors on the front facade of an infill house should be located in similar proportion and position as the original houses on the block.
- Attention should be paid to window placement and the ratio of solid (the wall) to void (the window and door openings).
- Contemporary windows such as "picture windows" should not be used in pre-World War II neighborhoods.

7. Roof Shapes and Materials

- New roofs should be designed to have a similar pitch to original housing on the block
- More complex roofs, such as hipped roofs and dormers, should be part of new housing designs when such forms were historically used on the block.
- Darker shades of shingle were often used and should be chosen in roofing houses in Heart of Knoxville neighborhoods.

8. Siding Material

- Clapboard-like materials (such as cement fiberboard) should be used in constructing new housing where painted wood siding was traditionally used.
- Brick, wood shingle, and other less common material may be appropriate in some older neighborhoods, particularly those with a mix of architectural styles.

- Faced stone, vertical siding, and other non-historic materials should not be used in building new houses. In 1930-1950 era neighborhoods, faced stone may be appropriate (see Section 12).
- 11. Landscape and Other Considerations
- One native or naturalized shade tree should be planted in the front and rear yards of in fill lots with 25 feet or more in depth to front of house.
- 12. Small Lot 1930-1950 Era Houses:
- In blocks where entrances are dramatized by stoops, infill housing should feature a stoop (measuring 4 to 5 feet in depth) or a covered porch (6 to 8 feet in depth)

Comments

- 1. The house is proposed to be set 28.5' from the front property line to the entry stoop, which measures 4' deep; the main massing of the house would be 32.5' from the front property line. The average front setback of the blockface is 40.2', with the adjacent house at 39'. The house should be recessed towards the rear to align with the adjacent house, and the overall front setback pattern of the block.
- 2. The block to receive new construction is characterized by Minimal Traditional houses. There are several comparable houses in the surrounding neighborhood, featuring 1.5-story, front-gable roof massings with nested front gables or entry stoops, particularly on the 3300 block of Bellevue Street. The proposed house aligns with the Tudor Revival style shown in the design guidelines and called out as prevalent in the "grid streets near Emoriland." The 1.5-story residence is proportional to the dimensions of the lot and the other houses on the block.
- 3. The proposed parking meets the Infill Housing design guidelines as located behind the house and accessed from the secondary street. Final site plan modifications may be necessary to meet city Engineering standards.
- 4. Overall, the 1.5-story, three-bay façade is similar in scale and width to the context, in particular on a block characterized by Minimal Traditional houses where the wider elevation faces the street. The neighborhood's foundations are not as tall as other historic neighborhoods in Knoxville but the final foundation should be at least 12" tall to be compatible with the context.
- 5. The proposed entry stoop meets the guidelines for front porches in neighborhoods characterized by "small lot 1930-1950-era houses," with a 4' by 5' entry stoop with a steeply pitched front-gable roof. The rounded arch over the door contributes additional complexity.
- 6. Guidelines recommend window and door styles be compatible with historic houses on the block, with a consistent ratio of solid to void. The façade uses a variety of window sizes and designs, while the neighborhood features primarily double-hung windows. The Board should discuss if double-hung windows are preferable to the multi-light casements on this design.
- 7. Overall, the roof pitch meets the design guidelines, though the 6/12-pitch massing projecting towards the rear is a unique element for the neighborhood context.
- 8. Design guidelines note that "clapboard-like materials should be used where wood siding was typically used," and "brick may be appropriate in some older neighborhoods, particularly those with a mix of architectural styles," and "other non-historic materials should not be used in building new houses." The proposed stucco-esque acrylic coating is not compatible with the context. The acrylic should be revised to brick or lap siding to reflect the other siding materials on the house.
- 9. The application includes extensive information on trees to be retained and planted.

Recommendation

Staff recommends approval of Certificate 4-D-4-IH, subject to the following conditions: 1) front setback to be revised to align with adjacent house and blockface; 2) foundation to measure at least 12" tall; 3) proposed acrylic coating cladding to be replaced with brick or lap siding.



INFILL HOUSING REVIEW BOARD


APPLICATION FOR CERTIFICATE OF APPROPRIATENESS



3221 Bellevue St.

Edgewood Park Infill Housing Overlay District

Original Print Date: 4/3/2024 Revised: Knoxville/Knox County Planning - Infill Housing Design Review Committee

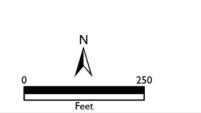



DESIGN REVIEW REQUEST

☐ DOWNTOWN DESIGN (DK)

☐ HISTORIC ZONING (H)

KNOXVILLE I KNOX COUNTY	NFILL HOUSING (IH)			
Christopher Smith				
Applicant				
03/28/2024	04/17/2024		4-D-24-IH	ł
Date Filed	Meeting Date (if applicable	5)	File Numbe	r(s)
CORRESPONDENCE				
All correspondence related to this application	n should be directed to the	approved contact lis	ted below.	
■ Owner □ Contractor □ Engineer	☐ Architect/Landscape A	rchitect		
Christopher Smith				
Name		Company		
3217 Bellevue Street		Knoxville	TN	37917
Address		City	State	Zip
931-561-0069	csmit272@gmail.com			
Phone	Email			
CURRENT PROPERTY INFO	3217 Bellevue St	reet		1-561-0069
Owner Name (if different from applicant)	Owner Address		Ow	vner Phone
3221 Bellevue Street		070PA052	01	
Property Address		Parcel ID		
FAIRMONT PARK ADD		R2		
Neighborhood		Zoning		
AUTHORIZATION				
Lindsay Crockett Staff Signature	Lindsay Crockett		4.	1.24
Staff Signature	Please Print		Da	te
	Christopher Smit	h	03	3/28/2024
Applicant Signature	Please Print		 Da	te

REQUEST

DOWNTOWN DESIGN	Level 1: ☐ Signs ☐ Alteration of an existing building/structure Level 2: ☐ Addition to an existing building/structure Level 3: ☐ Construction of new building/structure ☐ Site design, parking, plazas, I See required Downtown Design attachment for more details. ☐ Brief description of work:		
HISTORIC ZONING	Level 1: Signs Routine repair of siding, windows, roof, or other features, in-ki Level 2: Major repair, removal, or replacement of architectural elements or material Level 3: Construction of a new primary building Level 4: Relocation of a contributing structure Demolition of a contributing structure Brief description of work: Brief description of work:	ls	
INFILL HOUSING	Level 1: Driveways, parking pads, access point, garages or similar facilities Sur Level 2: Additions visible from the primary street Changes to porches visible for Level 3: New primary structure Site built Modular Multi-Sectional See required Infill Housing attachment for more details. Brief description of work: New 2 story residential house to be built at 3221 Belle	rom the primary street	
STAFF USE ONLY	ATTACHMENTS Downtown Design Checklist Historic Zoning Design Checklist Infill Housing Design Checklist ADDITIONAL REQUIREMENTS Property Owners / Option Holders Level 1: \$50 • Level 2: \$100 • Level 3: \$250 • Level 4: \$500	FEE 1: 250.00 FEE 2: FEE 3:	TOTAL: 250.00

New Residential Construction Proposal

The proposal is for a two-story residential home to be built at 3221 Bellevue Street. The following pages contain supporting documentation for the proposal.

DESIGN GUIDELINES CHECK LIST

Use the following check list to determine the appropriateness of proposed infill housing design for the Heart of Knoxville. For each unchecked item, please refer to the appropriate Heart of Knoxville Infill Housing Design Guidelines section.

Front Yards

Section 1, page 5

- Setback and front door are in line and consistent with original houses on the block.
- Porch and habitable portion of house is offset from street equal to neighboring houses.
- Walkway is proposed from sidewalk (when available) to front door, perpendicular to street.
- masonry, wide boards, and other contemporary materials.
- Healthy trees are marked for preservation.

House Orientation and Side Yards

Section 2, page 6

- Proposed infill is proportional to dimensions of lot and original houses on the block.
- Proposed infill on corner lots has applied for any necessary zoning variance to locate closer to side street.
- Proposed infill keeps the spacing between houses consistent with original houses on the block.

Alleys, Parking, and Services

Section 3, page 7

- Proposed parking avoids the front yard.
- N/A Proposed infill house has access from alley only (where available) for garage or parking pad. (If no alley access exists, proposed garage or parking pad extends 20 feet beyond the front façade of proposed infill house.)
- N/A Proposed garages accessed by alley are setback at least 18 feet from centerline of alley pavement.
 - ☐ Proposed parking pads, utility boxes, and waste collection points are visually screened by landscaping and/or fencing.

Scale, Mass, and Foundation Height

Section 4, page 8

- Proposed infill elevation is proportional in scale to the original houses on the block.
- Proposed infill façade respects width of older houses on the block.
- Proposed infill attempts to incorporate historic elements of the block into the design.
- Foundation height is consistent with original houses on the block.
- Fencing is constructed of traditional materials and excludes chain link, N/A M Additions that cannot conform to scale and height of streetscape are located to the side or rear of infill lot.

Porches and Stoops

Section 5, page 9

- Proposed infill includes plans for a porch in a neighborhood where porches are dominant.
- Proposed porch is proportional to existing porches on block.
- Proposed porch maintains consistency with existing porches in setback along the street.
- Proposed porch materials and details complement the historic character and style of neighborhood (refer to Appendix C).

Windows and Doors

Section 6, page 10

- Proposed window and door styles complement historic character and style of block (refer to appendix).
- Proposed window or door positioning does not violate the privacy of neighboring homes.
- Proposed infill excludes contemporary window styles in pre-1940 areas.
- Proposed infill respects window and door placement of older houses on the block.

Roof Shapes and Materials

Section 7, page 12

- Proposed infill specifies similar pitch to existing houses on block.
- Proposed infill respects complex roof forms of historic blocks (refer to appendix).
- Proposed infill for a pre-1940 neighborhood specifies darker shades of shingle roofing.

Siding Materials

Section 8, page 13

- **N/A** In a neighborhood dominated by painted wood siding, the proposed infill specifies clapboard or similar substitutes.
 - In a neighborhood with mixed architectural styles, the proposed infill specifies appropriate material and detail.
 - ☐ The proposed infill excludes faced stone, vertical siding, and other non-historic materials.

N/A Additions

Section 9, page 14

- Proposed additions to existing houses respect siding and roof materials, as well as door and window styles original to the house.
- Proposed window or door replacements should respect original style (refer to Appendix C).
- Proposed additions are located to the side or rear of original house.
- Proposed additions which require additional height are located to the rear of the house.
- Specified roof line and roofing materials for proposed addition respect original house.
- Proposed addition does not violate openness or character of front porch.

N/A Multi-unit Housing

Section 10, page 15

- Proposed multi-unit housing respects traditional front yard setbacks of neighborhood.
- Proposed multi-unit housing respects height of original houses in the neighborhood.
- Proposed multi-unit housing respects rhythm and proportion of historic homes on the block.
- Proposed parking for multi-unit housing accesses existing alleys.
- Proposed housing specifies landscaping to include shade trees, in front and back yards.

Landscape and Other Considerations

Section 11, page 16


- For proposed infill with 25 feet or greater front yard depth, at least one shade tree is specified for planting.
- N/A Specified fencing and/or hedges will not exceed 42 inches in height in front yard.
- N/A Front yard fences avoid chain link and specify appropriate historic material.


Small Lot 1930-1950 Era Houses

Section 12, page 17

- Off-street parking is located in the side or rear yard or parallel to the street.
- N/A Multi-unit housing is in scale with other houses on the block and across the street.
 - A porch or stoop is part of the design.
 - Decks or patios are located behind the house. N/A

Site Plan

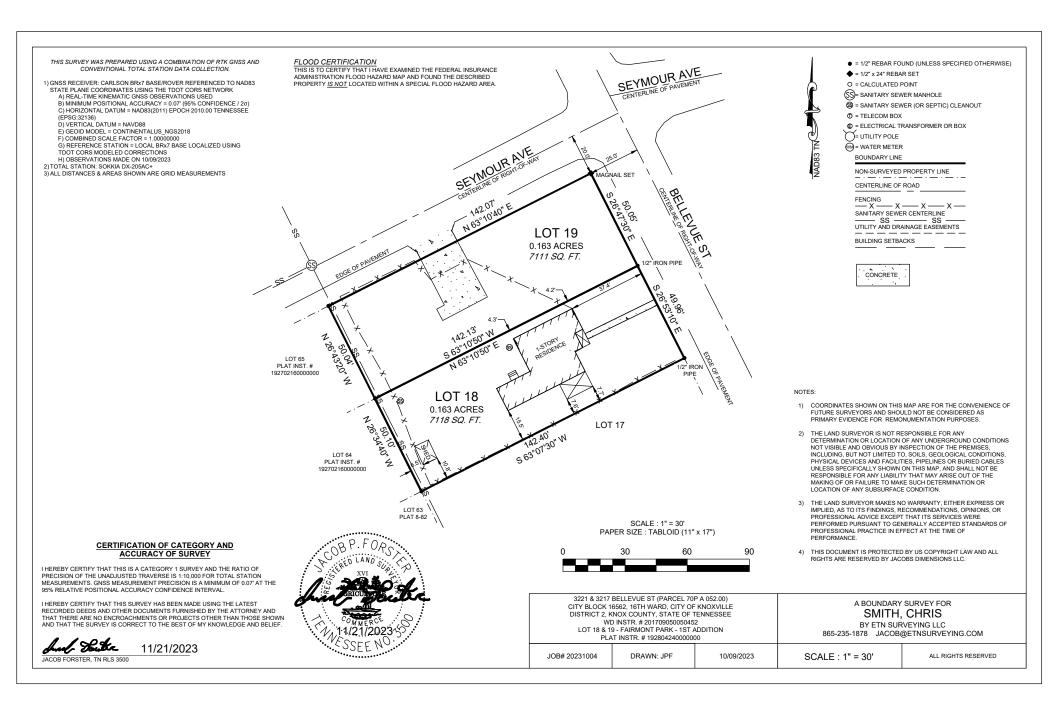


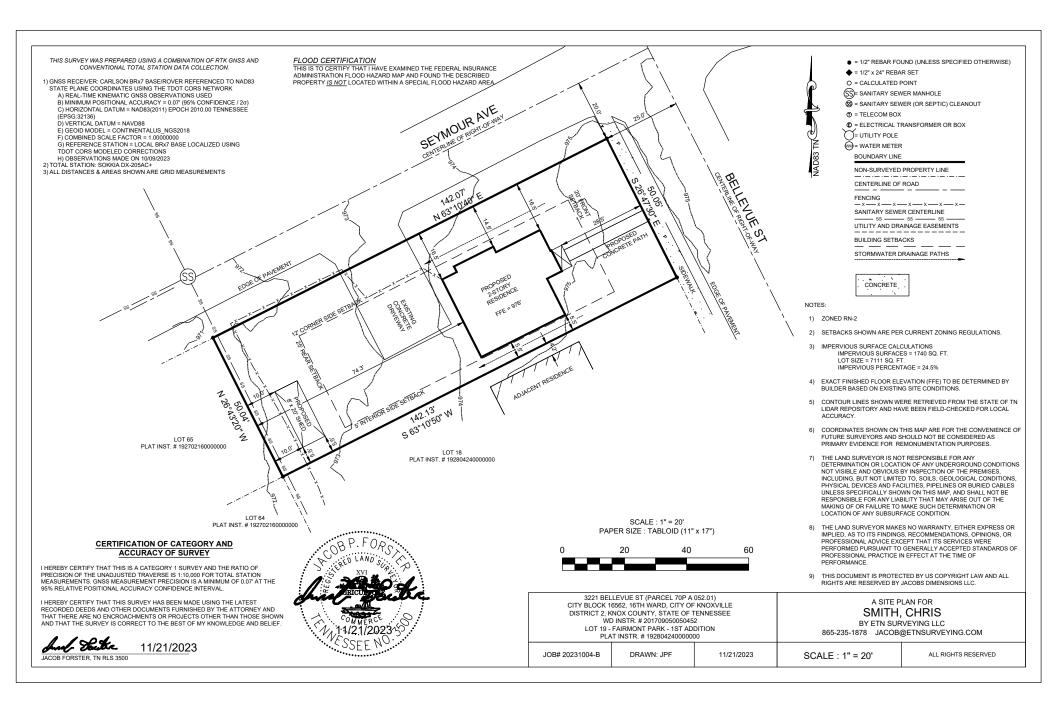

Site Plan with Trees and Fence

The next page indicates trees and fencing on the property:


- Two existing trees in the backyard (Oak and Buckeye) that will be preserved.
- The front right tree will be a new Dogwood variety that will provide shade. There
 is a current dogwood variety on the property that will unfortunately be cut down
 for the placement of the house.
- The front left tree will be a new smaller variety of Dogwood. Current trees in the location that will be removed include: 1) a Crepe Myrtle that is directly under the power lines and is now beginning to touch the lines and 2) a young Pecan tree that is directly in the corner of the power lines and will continue to get larger.
- Fencing is highlighted in red. The back fence line remains the same. The
 fencing will be vertical wood similar to other privacy fences in the neighborhood.
 A wooden gate will also be installed on the parking pad.

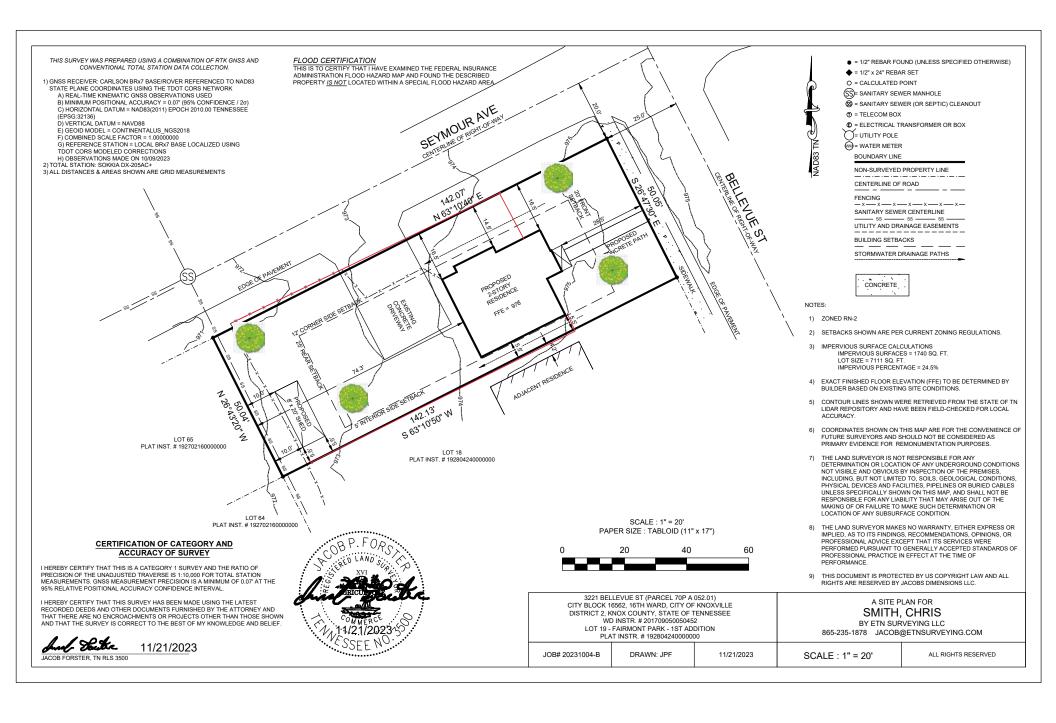

Blueprints with Building Elevations

The next page details the blueprints for the residential house to be built. Please note the blueprint includes a basement which will not be built. The house will be built on a slab foundation, but the elevations above ground are correct. In addition, the concrete patio is to be enclosed as an office space. The blueprints contain materials to be used.

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CUSTOMER INFO

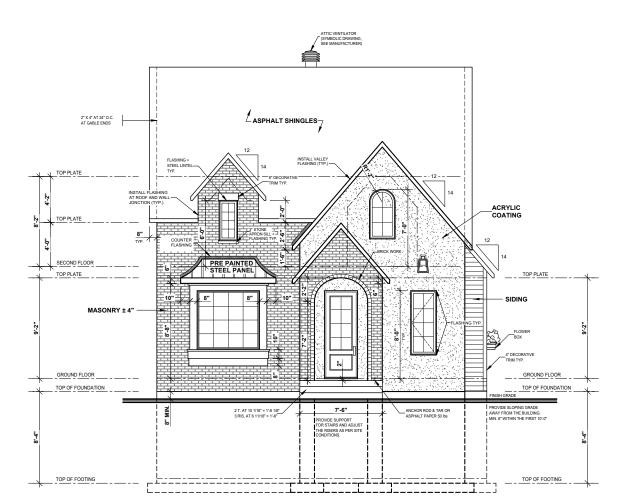CHRIS SMITH (931)980-7188

AREA SCHEDULE / SQ.FT. GROUND FLOOR 818 SECOND FLOOR 877 BASEMENT 818 TOTAL 2513 OTHERS BONUS ROOM GARAGE

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PROJECT INFO

NEW CONSTRUCTION

(FINISHED BASEMENT)

DRAWING

FRONT ELEVATION

SCALE	1/4"=1'-0"	DESIGNED BY	J.L.
DATE	12/10/2023	DRAWN BY	A.R.
PLAN NO.	3513-V1	CHECKED BY	M.S.
SHEET NO.		1	-13

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CUSTOMER INFO

CHRIS SMITH

(931)980-7188

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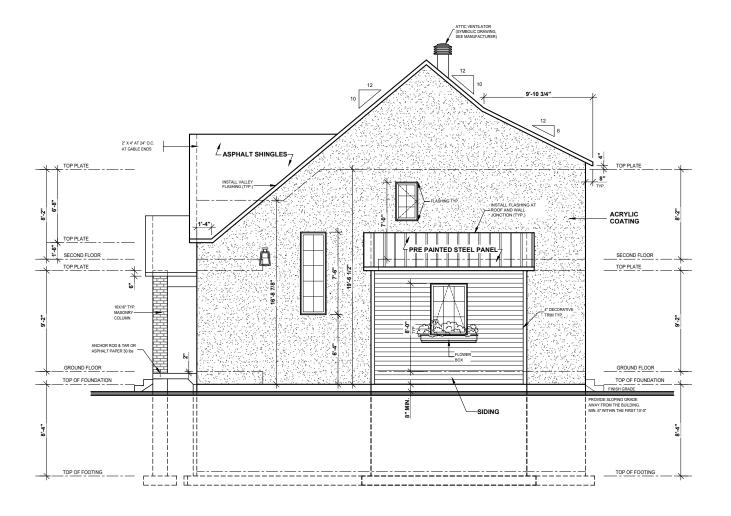
PROJECT INFO

NEW CONSTRUCTION (FINISHED BASEMENT)

DRAWING

RIGHT ELEVATION

SCALE	1/4"=1'-0"	DESIGNED BY	J.L.
DATE	12/10/2023	DRAWN BY	A.R.
PLAN NO.	3513-V1	CHECKED BY	M.S.
SHEET NO.		2	-13



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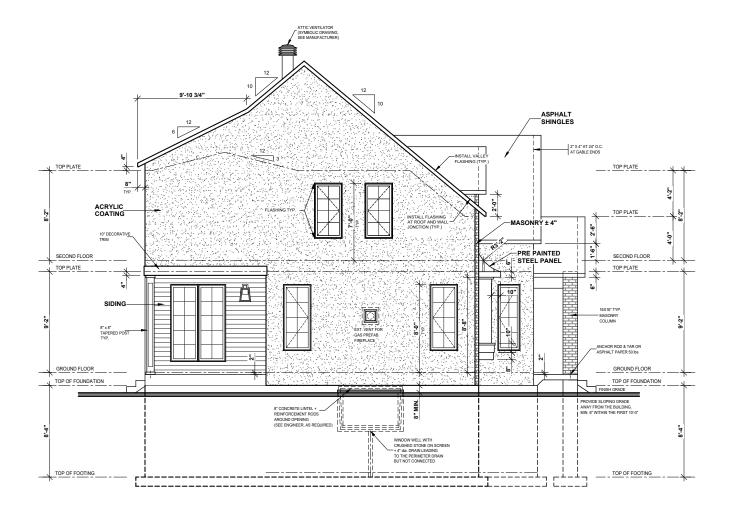
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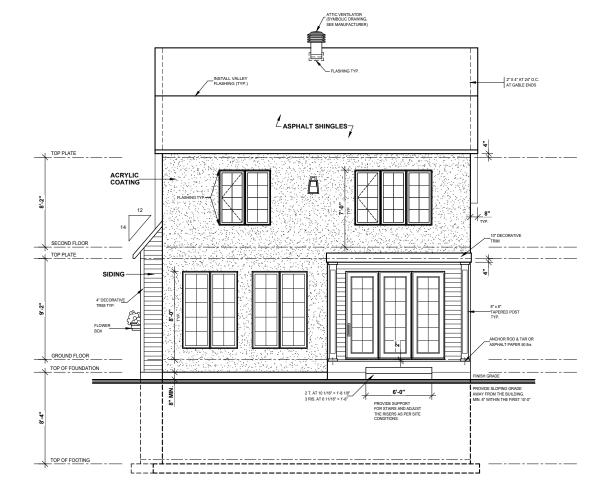
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LEFT ELEVATION

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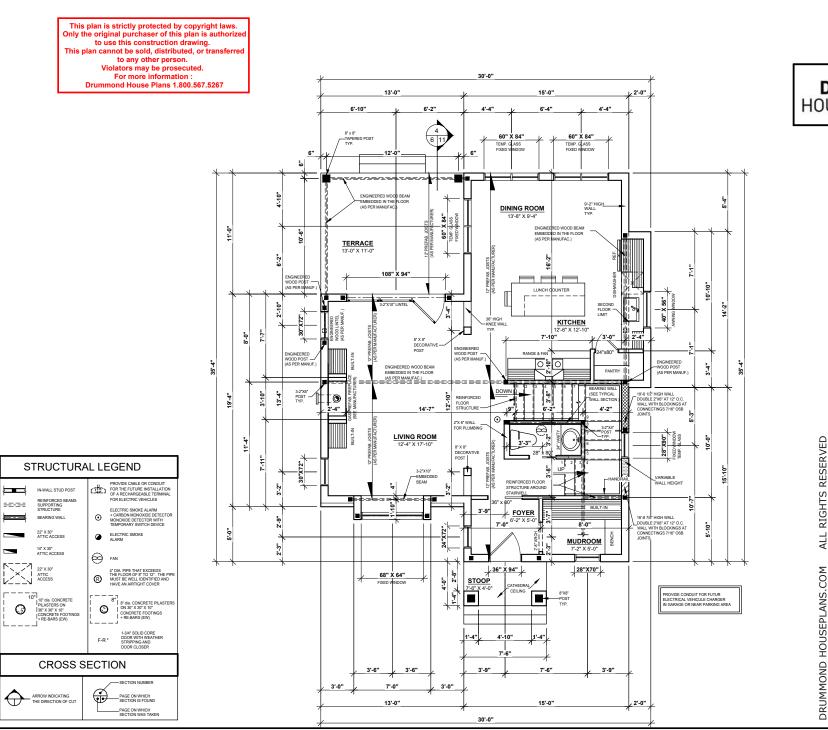
DRAWING

REAR ELEVATION

SCALE	1/4"=1'-0"	DESIGNED BY	J.L.
DATE	12/10/2023	DRAWN BY	A.R.
PLAN NO.	3513-V1	CHECKED BY	M.S.
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CHRIS SMITH (931)980-7188

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NEW CONSTRUCTION (FINISHED BASEMENT)

DRAWING

GROUND FLOOR PLAN

SCALE	1/4"=1'-0"	DESIGNED BY	J.L.
DATE	12/10/2023	DRAWN BY	A.R.
PLAN NO.	3513-V1	CHECKED BY	M.S.
SHEET NO.		6-	-13

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CUSTOMER INFO

CHRIS SMITH

(931)980-7188

AREA SCHEDULE / SQ.FT		
GROUND FLOOR	818	
SECOND FLOOR	877	
BASEMENT	818	
TOTAL	2 513	
OTHERS		
BONUS ROOM		
GARAGE		

RESERVED

RIGHTS

ALL

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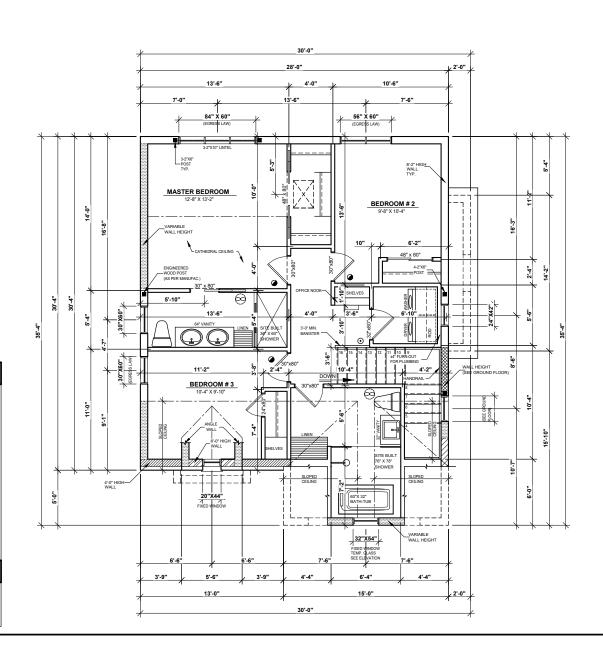
STAMP BY

PROJECT INFO

NEW CONSTRUCTION (FINISHED BASEMENT)

DRAWING SECOND FLOOR PLAN

SCALE	1/4"=1'-0"	DESIGNED BY	J.L.	
DATE	12/10/2023	DRAWN BY	A.R	
PLAN NO.	3513-V1	CHECKED BY	M.S	
SHEET NO.		7-13		



PROVIDE CABLE OR CONDUIT
FOR THE FUTURE INSTALLATION
OF A RECHARGEABLE TERMINAL
FOR ELECTRIC VEHICLES REINFORCED BEAMS ==-== ELECTRIC SMOKE ALARM

+ CARBON MONOXIDE DETECTOR
MONOXIDE DETECTOR WITH
TEMPORARY SWITCH DEVICE BEARING WALL 22" X 30" ATTIC ACCESS € FAN 22" X 30" ATTIC ACCESS 4" DIA. PIPE THAT EXCEEDS THE FLOOR OF 8" TO 12". THE PIPE MUST BE WELL IDENTIFIED AND HAVE AN AIRTIGHT COVER ®

STRUCTURAL LEGEND

()

IN-WALL STUD POST

8" 8" dis. CONCRETE PILASTERS ON 30" X 30" X 10" CONCRETE FOOTINGS I + RE-BARS (EW) 0

1-3/4" SOLID CORE DOOR WITH WEATHER STRIPPING AND DOOR CLOSER


CROSS SECTION

ARROW INDICATING
THE DIRECTION OF CUT

-SECTION NUMBER PAGE ON WHICH SECTION IS FOUND This plan is strictly protected by copyright laws. Only the original purchaser of this plan is authorized to use this construction drawing.

For more information : Drummond House Plans 1.800.567.5267

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NOTES

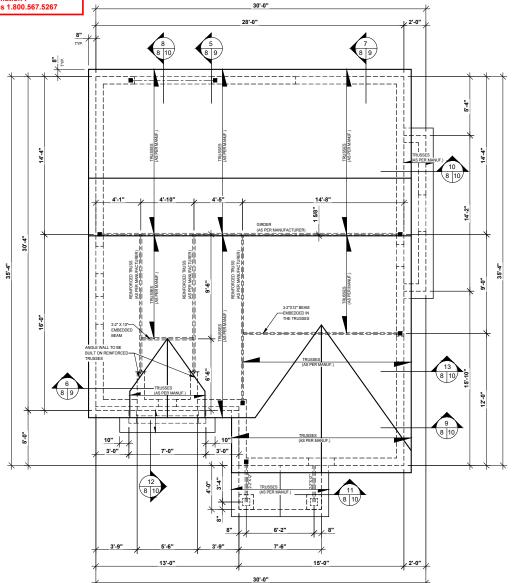

CUSTOMER INFO

CHRIS SMITH

(931)980-7188

	AREA SCHEDULE / SQ.FT			
I	GROUND FLOOR	818		
	SECOND FLOOR	877		
	BASEMENT	818		
ı	TOTAL	2 513		
	OTHERS			
	BONUS ROOM			
ı	GARAGE			

STAMP BY

PROJECT INFO

NEW CONSTRUCTION (FINISHED BASEMENT)

DRAWING

ROOF PLAN

SCALE	1/4"=1'-0"	DESIGNED BY	J.L.
DATE	12/10/2023	DRAWN BY	A.R.
PLAN NO.	3513-V1	CHECKED BY	M.S.
SHEET NO.		8	- 13

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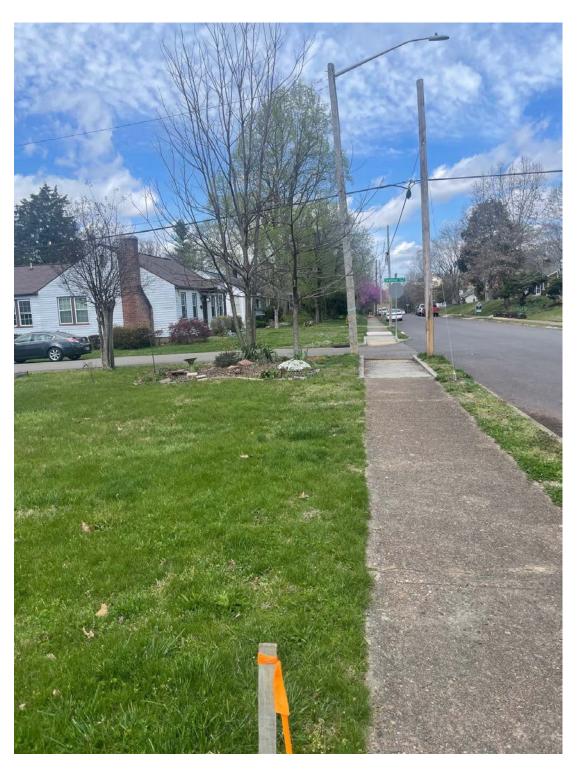
Photos of Property



Front Corner of Property

Current Dogwood - to be replaced due to placement of house


New Dogwood to be planted closer to sidewalk.



Horizontal Front of Property

Pecan tree and Crepe Myrtle tree to be replaced at corner.

New tree will be smaller variety and away from power lines.

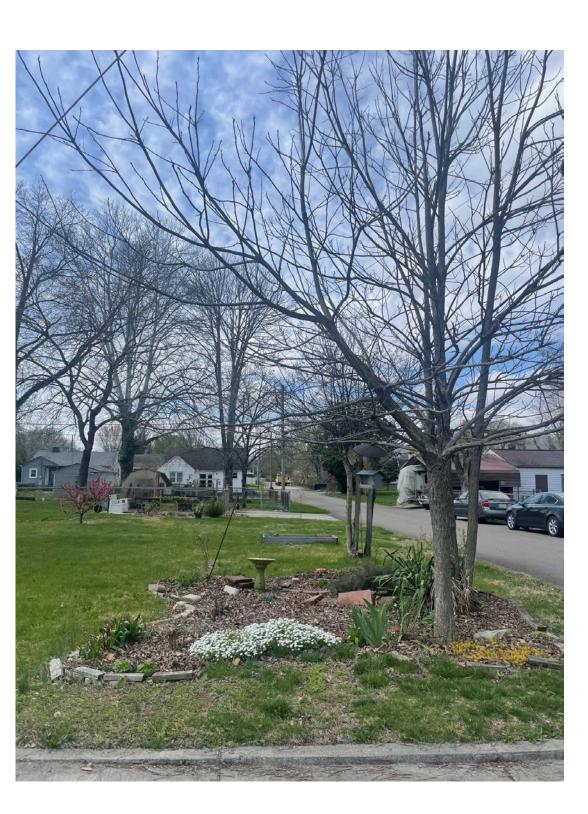

Front Corner of Property

Pecan tree to be replaced




Middle of Lot - Parking Pad

Parking pad to be retained.

Chain link fence will be replaced with wooden fence.

Oak tree in background will be retained.

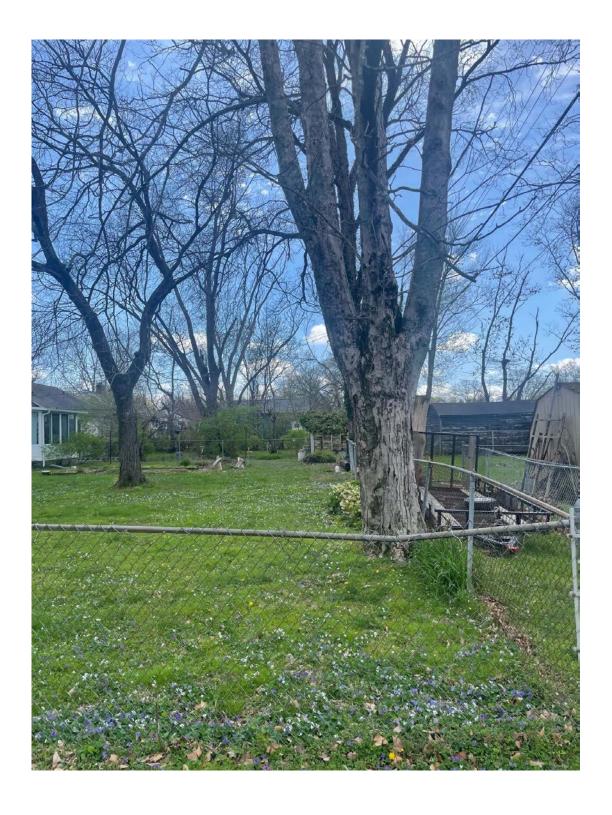

Back Corner

Left tree is the Oak tree to be preserved.

Front right tree is a Buckeye that will also be preserved.

Personal Note

My name is Chris Smith and I currently live at 3217 Bellevue Street with my wife, Kristen, and son, Callen, who was born on 03/14/2024. We both graduated from the University of Tennessee Knoxville and decided that we both loved the city so much that we never wanted to leave. I currently work at TVA downtown as an auditor and my wife is a nurse at UT Medical Center. We bought our current home in 2017 and have loved every moment of living in the area. North Knoxville is such a great place to be and especially in the Fairmont and Edgewood area. We recently split our double lot in hopes of building a bigger house to accommodate our growing household. Our house design represents a more classic look that fits in with the very diverse architecture that is present around our area. We appreciate you all taking the time to review our application and look forward to hopefully building our family home.

