

# **Staff Report**

# Infill Housing Design Review Committee

File Number: 11-E-23-IH

Meeting: 11/15/2023

**Applicant:** Amber Culpepper Lafayette Investments, LLC **Owner:** Amber Culpepper Lafayette Investments, LLC

## **Property Information**

Location: 3415 Gap Rd. Parcel ID 81 | T 011

**Zoning:** RN-2 (Single-Family Residential Neighborhood)

**District:** Lonsdale Infill Housing Overlay District

## **Description of Work**

Level III New Primary Structure

After-the-fact review of revisions to the previously approved COA (3-H-22-IH). Approved site plan and elevation drawings are included in application packet, to be compared with photos of existing conditions. A photo of the remainder of the street, as completed, is included in the application packet as reference.

Some variations from the approved drawings include: foundation height (shown as approximately 2' on approved drawings); front porch foundation (shown as an enclosed foundation resting on the grade, instead of an elevated open deck-style foundation); front porch design (shown as a partial-width, shed-roof porch supported by two columns on approved designs); side elevation windows (at least one not installed as shown); siding design (board-and-batten on façade with Dutch lap siding on the side elevations).

# **Applicable Design Guidelines**

Heart of Knoxville Infill Housing Design Guidelines

Scale, Mass, and Foundation Height

- The front elevation should be designed to be similar in scale to other houses along the street.
- The front façade of new houses should be about the same width as original houses on the block.
- New foundations should be about the same height as the original houses in the neighborhood.

#### Porches and Stoops

- Porches should be part of the housing design in those neighborhoods where porches were commonplace.
- Porches should be proportional to original porches on the block, extending about 8-12 feet toward the street from the habitable portion of the house.
- Porches should extend into the front yard setback, if necessary, to maintain consistency with similarly sited porches along the street.
- Porch posts and railings should be like those used in the historic era of the neighborhood's development. Wrought iron, "antebellum" columns and other materials that were not used in the early 1900's should not be used.

#### Windows and Doors:

- When constructing new houses, the window and door styles should be similar to the original or historic houses on

the block.

- To respect the privacy of adjacent properties, consider the placement of side windows and doors.
- The windows and doors on the front facade of an infill house should be located in similar proportion and position as the original houses on the block.
- Attention should be paid to window placement and the ratio of solid (the wall) to void (the window and door openings).

Roof Shapes and Designs:

- New roofs should be designed to have a similar pitch to original housing on the block.
- Darker shades of shingle were often used and should be chosen in roofing houses in Heart of Knoxville neighborhoods.

#### Siding Material:

- Clapboard-like materials (such as cement fiberboard) should be used in constructing new housing where painted wood siding was traditionally used.
- Brick, wood shingle, and other less common material may be appropriate in some older neighborhoods, particularly those with a mix of architectural styles.

Landscape and Other Considerations:

- One native or naturalized shade tree should be planted in the front and rear yards of in fi ll lots with 25 feet or more in depth to front of house.

#### **Comments**

3413 and 3415 Gap Road, along with five other new houses along Gap Road, were reviewed and approved by the DRB in March 2022. Planning staff reviewed and stamped the final elevation drawings and site plans for permitting in April 2022. By spring 2023, at least five of the houses were completed, received Certificates of Occupancy, and several have been sold. At the time, Plans Review and Inspections staff did not identify any discrepancies with the COAs or notify Planning staff of issues.

Field inspectors identified discrepancies with the COAs for 3413 and 3415 Gap Road in August 2023. 3413 Gap Road has not received siding or porch finishes; 3415 Gap Road looks relatively complete and received a failed inspection.

Reviewing design elements such as foundation heights (when the foundations are already poured), window locations (when the fenestrations area already framed), and porch details is challenging and creates unnecessary delays and expense for the applicants. Additionally, when five adjacent houses with similar discrepancies from approved designs have already been completed and sold, modifying minor design elements on the two remaining has a negligible effect on the streetscape as built.


Applicants (including developers, architects, and contractors) are responsible for meeting the requirements of design-related zoning overlays, and should recognize when site conditions necessitate major design changes, Planning staff should be informed to avoid after-the-fact reviews.

City Plans Review and Inspections staff are responsible for enforcing the zoning code, which includes design-related overlays such as local historic districts and local infill housing overlays. Planning staff review elevation drawings that are submitted for permitting; field inspection should include review of COAs, site plans, and elevation drawings to ensure what is built complies with the zoning code.

#### Recommendation

The Board, Plans Review and Inspections staff, and Planning staff should discuss an appropriate path forward for enforcement of the zoning code and design guidelines.

age 3 of 3	Planner in Charge: Lindsay Crockett	11-E-23-IH	11/7/2023 2:45:58 PI
The Board should ide COAs issued in Marcl	entify if any changes should be made to bring 3. n 2022.	413 and 3415 Gap Roa	id into compliance with
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# DESIGN REVIEW REQUEST

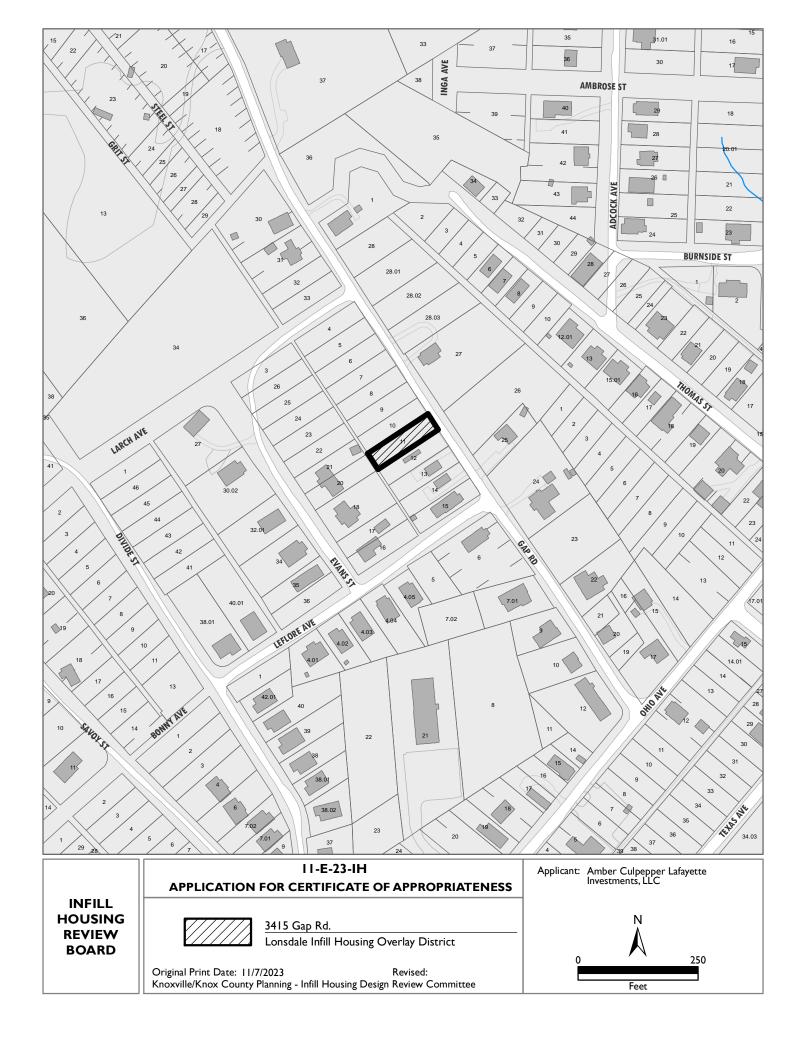☐ DOWNTOWN DESIGN (DK)

☐ HISTORIC ZONING (H)

KNOXVILLE I KNOX COUNTY	NFILL HOUSING (IH)		
Applicant		11-E-23-IH	
		11 L 23 111	
Date Filed	Meeting Date (if applicable)	File Number(s)	
CORRESPONDENCE			
All correspondence related to this applicatio	n should be directed to the approved contact	listed below.	
☐ Owner ☐ Contractor ☐ Engineer	☐ Architect/Landscape Architect		
Name	Company		
Address	City	State Zip	
Phone	Email		
CURRENT PROPERTY INFO			
Owner Name (if different from applicant)	Owner Address	Owner Phone	
Property Address	Parcel ID		
Neighborhood	Zoning		
AUTHORIZATION			
Lindsay Crockett Staff Signature	Lindsay Crockett	10.27.23	
Staff Signature 💋	Please Print	Date	
Amber Culpepper			
Applicant Signature	Please Print	Date	


# **REQUEST**

DOWNTOWN DESIGN	Level 1:  ☐ Signs ☐ Alteration of an existing building/structure  Level 2: ☐ Addition to an existing building/structure  Level 3: ☐ Construction of new building/structure ☐ Site design, parking, plazas, landscape in the second process of the					
HISTORIC ZONING						
INFILL HOUSING						
STAFF USE ONLY	ATTACHMENTS  Downtown Design Checklist  Historic Zoning Design Checklist  Infill Housing Design Checklist  ADDITIONAL REQUIREMENTS  Property Owners / Option Holders  Level 1: \$50 • Level 2: \$100 • Level 3: \$250 • Level 4: \$500	FEE 1: 100.00 FEE 2: FEE 3:	TOTAL: 100.00			

## Lafayette Investments, LLC / 3-H22-IH 10/24/2023 Infill Housing Attachment 3415 Gap Road

### **Brief description of work:**

- 1. The original site plan wasn't correct based on the topography of the land. We were forced to change front porch and stair design. When looking at the home, the right front corner measures 6'5" from the ground to the bottom of the porch. The left corner is 10'2".
- 2. The siding material was changed to vinyl siding rather than Hardie Board, due to the increased cost of construction materials and to keep this project viable from an overall cost perspective.
- **3.** 6x6 posts are used we only added the vinyl wrap rather than painting the posts. This looks better aesthetically and will also withstand the weather conditions better and last longer.
- **4.** Due to difficulty entering and exiting the driveway, a bay window was removed from the side of the home. It would have encroached upon the driveway.
- **5.** The porch handrails are metal with a white protective coating and horizonal design. This was done for the aesthetic reasons and also to provide a longer lasting, more maintenance-free material.

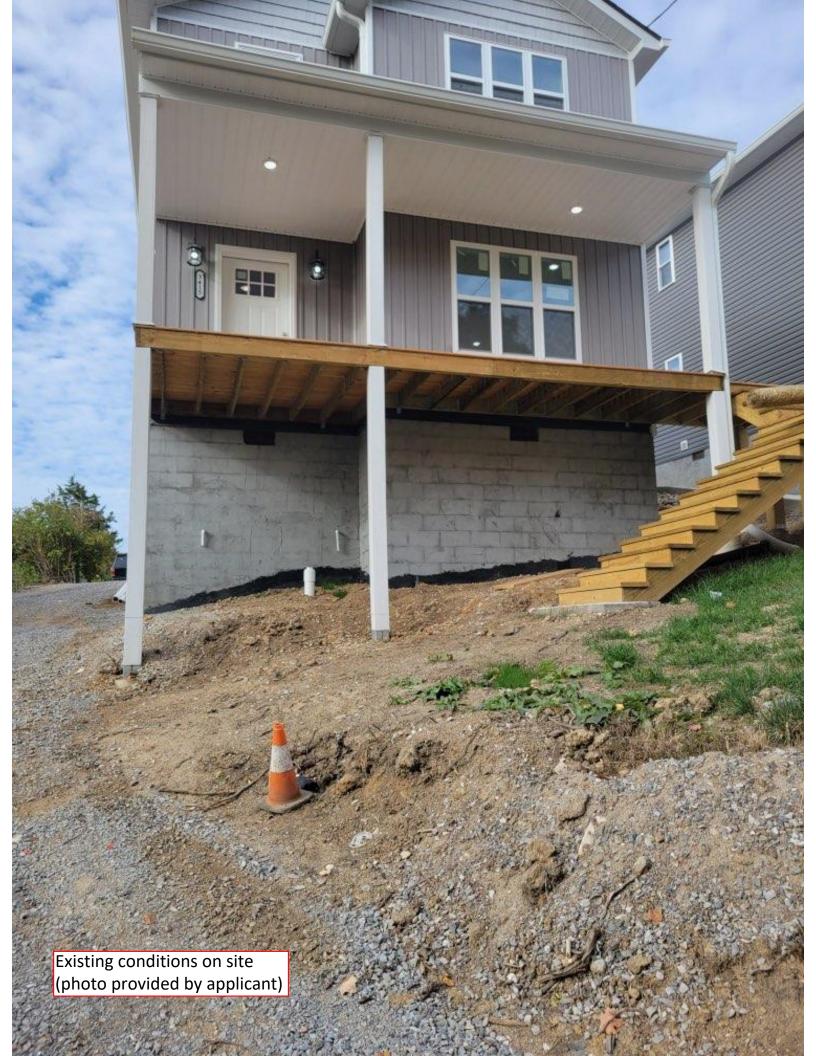

#### INFILL CHECKLIST FRONT YARDS - SECTION 1, PAGE 5

- N/A SETBACK AND FRONT DOOR ARE IN LINE AND CONSISTENT WITH ORIGINAL HOUSES ON THE BLOCK.
- X PORCH AND HABITABLE PORTION OF THE HOUSE IS OFFSET FROM STREET EQUIAL TO NEIGHBORING HOUSES.
- N/A WALKWAY IS PROPOSED FROM SIDEWALK (WHEN AVAILABLE) TO FRONT DOOR, PERPENDICULAR TO STREET.
- N/A FENCING IS CONSTRUCTED OF TRADITIONAL MATERIALS AND EXCLUDES CHAIN LINK, MASONRY, WIDE BOARDS, AND OTHER CONTEMPORARY MATERIALS.
- HEALTHY TREES ARE MARKED FOR PRESERVATION.

## HOUSE ORIENTATION AND SIDE YARDS - SECTION 2, PAGE 6

- N/A PROPOSED INFILL IS PROPORTIONAL TO DIMENSION OF LOT AND ORIGINAL HOUSES ON THE BLOCK.
- N/A PROPOSED INFILL ON CORNER LOTS HAS APPLIED FOR ANY NECESSARY ZONING VARIANCE TO LOCATE CLOSER TO SIDE STREET.
- N/A PROPOSED INFILL KEEPS THE SPACING BETWEEN HOUSES CONSISTENT WITH ORIGINAL HOUSES ON THE BLOCK.

#### ALLEYS, PARKING, AND SERVICES - SECTION 3, PAGE 7 PROPOSED PARKING AVOIDS THE FRONT YARD.

- N/A PROPOSED INFILL HOUSE HAS ACCESS FROM ALLEY ONLY (WHERE AVAILABLE) FOR GRANGE OR PARKING PAD. (IF) NO ALLEY EXISTS, PROPSED GARAGE OR PARKING PAD EXTENDED SOME STATE OF PROPOSED INILL HOUSE.)
- ALLEY ARE SETBACK AT LEAST 18' FROM CENTERLINE OF ALLEY PAVEMENT.
- PROPOSED PARKING PADS, UTILITY BOXES, AND WASTE COLLECTION POINTS ARE VISUALLY SCREENED BY LANDSCAPING AND/OR FENCING.

#### SCALE, MASS, & FOUNDATION HEIGHT - SECTION 4, PAGE 8

- N/A PROPSED INFILL ELEVATION IS PROPORTIONAL IN SCALE TO THE ORIGINAL HOUSES ON THE BLOCK.
- N/A PROPOSED INFILL FACADE RESPECTS THE WIDTHS OF OLDER HOUSES ON THE BLOCK.
- N/A PROPOSED INFILL ATTEMPTS TO INCORPORATE HISTORIC ELEMENTS OF THE BLOCK INTO THE DESIGN.
- N/A FOUNDATION HEIGHT IS CONSISTENT WITH ORIGINAL HOUSES ON THE BLOCK.
- N/A ADDITIONS THAT CANNOT CONFORM TO SCALE AND HEIGHT OF STREETSCAPE ARE LOCATED TO THE SIDE OR REAR OF INFILL LOT.

#### PORCHES AND STOOPS - SECTION 5, PAGE 9

- PROPOSED INFILL IINCLUDES PLANS FOR A PORCH IN A NEIGHBORHOOD WHERE PORCHES ARE DOMINANT.
- PROPSED PORCH IS PROPORTIONAL TO EXISTING PORCHES ON BLOCK.
- PROPOSED PORCH MAINTAINS CONSISTENCY WITH EXISTING PORCHES IN SETBACK ALONG THE STREET.
- PROPOSED PORCH MATERIALS AND DETAILS COMPLEMENT RHE HISTORIC CHARACTER AND STYLE OF NEIGHBORHOOD (APPENDIX C).

#### WINDOWS & DOORS - SECTION 6, PAGE 10

- PROPOSED WINDOW AND DOOR STYLES COMPLEMENT HISTORIC CHARACTER AND STYLE OF BLOCK (REFER TO APPENDIX).
- PROPOSED WINDOW OR DOOR POSITIONING DOES NOT VIOLATE THE PRIVACY OF NEIGHBORING HOMES.
- N/A PROPOSED INFILL EXCLUDES CONTEMPORARY WINDOW STYLES IN PRE-1940 AREAS.
- PROPOSED INFILL RESPECTS WINDOW AND DOOR PLACEMENT OF OLDER HOUSES ON THE BLOCK.

#### ROOF SHAPES & MATERIALS - SECTION 7, PAGE 12

- PROPOSED INFILL SPECIFIES SIMILAR PITCH TO EXISTING HOUSES ON BLOCK.
- N/A PROPOSED INFILL RESPECTS COMPLEX ROOF FORMS OF HISTORIC BLOCKS.
- N/A PROPOSED INFILL FOR A PRE-1940 NEIGHBORHOOD SPECIFIES DARKER SHADES OF SHINGLE ROOFING.

#### SIDING MATERIALS - SECTION 8, PAGE 13


- N/A IN A NEIGHBORHOOD DOMINATED BY PAINTED WOOD SIDING, THE PROPOSED INFILL SPECIFIES CLAPBOARD OR SIMILAR SUBSTITUTES.
- IN A NEIGHBORHOOD WITH MIXED ARCHITECTURAL STYLES, THE PROPOSED INFILL SPECIFIES APPROPRIATE MATERIAL AND DETAIL.
- THE PROPOSED INFILL EXCLUDES FACED STONE, VERTICAL SIDING, AND OTHER NON-HISTORIC MATERIALS.


#### ADDITIONS - N/A

MULTI-UNIT HOUSING - N/A

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LANDSCAPE & OTHER CONSIDERATIONS - N/A



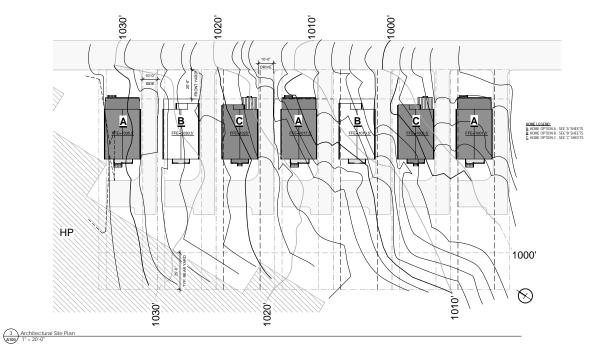

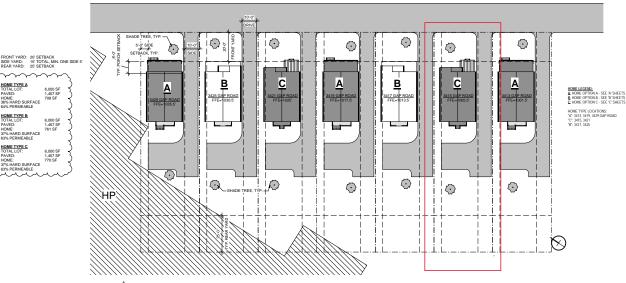Site Setbacks & Layout 1" = 20'-0" . ~ ~ ~ ~ ~ ~ ~ .

HOME TYPE A TOTAL LOT: PAVED: HOME: 36% HARD SURFACE 64% PERMEABLE

HOME TYPE B TOTAL LOT: PAVED: HOME: 37% HARD SURFACE 63% PERMEABLE

HOME TYPE C TOTAL LOT: PAVED: HOME: 37% HARD SURFACE 63% PERMEABLE

Planning PLAN REVIEW CERTIFICATION Plan Approved: Ru LLC 4.1.22 Zone: \_\_\_\_\_ RN2/IH Planning File #: \_\_\_ 3-H-22-IH

FAYETTE INVESTMENT GAP ROAD HOUSES ROAD, KNOXVILLE, TN  $\overline{\leq}$ GAP

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Drawn: MSG ARCHITECTURAL SITE PLAN

DATE: 11/22/2021 PROJECT: 21217 COPYRIGHT 2021





# GAP ROAD HOUSES - HOME OPTIONS LAFAYETTE INVESTMENTS 3415 GAP ROAD, KNOXVILLE, TN



Drawn: MSG

HOME OPTION C -EXTERIOR ELEVATIONS



Plan Approved: \_\_LLC 4.1.22 \_\_\_ Zone: \_\_\_\_ RN2/IH Planning File #: \_\_\_\_\_

