

Staff Report

Infill Housing Design Review Committee

File Number: 4-C-23-IH

Meeting: 4/19/2023
Applicant: Josh Braden
Owner: Josh Braden

Property Information

Location: 0 Chickamauga Ave. Parcel ID 81 B K 01101

Zoning: RN-2 (Single-Family Residential Neighborhood)

District: Oakwood/Lincoln Park Infill Housing Overlay District

Description of Work

Level III New Primary Structure

New primary residence fronting Chickamauga Avenue. One-and-one-half-story, cross-gable roof residence measuring 28' wide by 62' long, with a smaller front-gable roof massing projecting from the left half of the façade, adjacent to a recessed corner porch on the right. The house is proposed to be set 21' from the front property line. Parking is located behind the house and accessed from the alley, with an 18' by 64' concrete driveway.

The house features a 7/12 pitch on the primary side gable, with a 10/12 pitch on the centrally-located front gable; the roof will be clad in asphalt shingles. The exterior will be clad in fiber cement lap siding. Windows are 1/1 double-hung (no material specified) with 1 by 6 trim boards. The façade (north) features an 8' deep, recessed corner porch. A centrally located door is flanked by two bays of paired 1/1 double-hung windows.

The right side elevation features three different sizes of windows, including one double-hung window on the second-story gable field. The left elevation features three double-hung windows, including one in the upper gable field, and two small fixed windows. A screened-in porch is located on the rear corner of the property.

Applicable Design Guidelines

Heart of Knoxville Infill Housing Design Guidelines

- 1. Front Yards
- Consistent front yard space should be created along the street with the setback of a new house matching the older houses on the block.
- When several infill houses, porches and the habitable portion of each house should be about the same distance from the street as the original houses.
- A walkway should be provided from the sidewalk or street to the front door. Along grid streets, the walk should be perpendicular to the street.
- Healthy trees that are outside the building footprint should be preserved. The root area should be marked and protected during construction.
- 2. House Orientation and Side Yards
- New housing should be proportional to the dimensions of the lot and other houses on the block.

- Side yard setbacks should be similar to older houses on the block, keeping the rhythm of spacing between houses consistent.

3. Alleys, Parking, and Services

- Parking should not be in front yards.
- Alley access should be used for garage or parking pad locations.
- On streets without alleys, garages or parking pads should be at least 20' behind the front façade of the infill house with access limited to one lane between the street and the front façade.
- On those streets which have alleys, driveways should not be permitted from the front of the house.
- Alley oriented parking pads, garbage collection points, and utility boxes should be screened with a combination of landscaping and fencing.

4. Scale, Mass, and Foundation Height

- The front elevation should be designed to be similar in scale to the other houses along the street.
- The front façade of new houses should be about the same width as original houses on the block.
- If extensions or bays were typically part of the neighborhood's historic house design, such elements should be incorporated into infill housing.
- New foundations should be about the same height as the original houses in the neighborhood.
- If greater height is to be created (with new construction or an addition), that portion of the house should be located toward the side or rear of the property.

5. Porches and Stoops

- Porches should be part of the housing design in those neighborhoods where porches were commonplace.
- Porches should be proportional to original porches on the block, extending about 8-12' toward the street from the habitable portion of the house.
- Porches should extend into the front yard setback, if necessary, to maintain consistency with similarly sited porches along the street.
- Porch posts and railings should be like those used in the historic era of the neighborhood's development.

6. Windows and Doors

- When constructing new houses, the windows and door styles should be similar to the original or historic houses on the block.
- To respect the privacy of adjacent properties, consider the placement of side windows and doors.
- The windows and doors on the front façade of an infill house should be located in similar proportion and position as the original houses on the block.
- Attention should be paid to window placement and the ratio of solid (the wall) to void (the window and door openings).
- Contemporary windows such as "picture windows" should not be used in pre-World War II neighborhoods.

7. Roof Shapes and Materials

- New roofs should be designed to have a similar pitch to original housing on the block.
- More complex roofs, such as hipped roofs and dormers, should be part of new housing designs when such forms were historically used on the block.
- Darker shades of shingle were often used and should be chosen in roofing houses in Infill neighborhoods.

8. Siding Materials

- Clapboard-like materials should be used in constructing new housing where painted wood siding was traditionally used.
- Faced stone, vertical siding, and other non-historic materials should not be used in building new houses.

11. Landscape and Other Considerations

- One native or naturalized shade tree should be planted in the front and rear yards of infill lots with 25 feet or more in depth to front of house.

Comments

- 1. The house is proposed to be set 21' from the front property line at the closest point. The block has an irregular front yard pattern, with houses on the east side of the block set further from the street and moving closer as the block moves west. The average front setback of the block is 28' with the adjacent houses set 38' and 36' from the front property line. The front setback should move towards the rear of the property to align with the two surrounding houses. The final site plan should include a walkway from the front door to the street.
- 2. The block to receive new construction is characterized by one- and 1.5-story Minimal Traditionals and infill construction. The 1.5-story, three-bay residence Is proportional to the dimensions of the lot and the side yard setbacks are consistent with the block.
- 3. The proposed parking meets Infill Housing guidelines as the parking pad is accessed from the alley and located to the rear. The final site plan may need minor modifications to meet City Engineering standards. The final site plan should adhere to the base zoning requirements, including impervious surface limits.
- 4. Overall, the 1.5-story, three-bay façade is similar in scale to the context. The foundation height indicated on elevation drawings is consistent with the historic context.
- 5. The site plan includes an 8' deep front porch, recessed into the primary façade. The porch is compatible with the design of the house and the surrounding block. 8 by 8 posts may be more proportional to the façade, and final drawings may require a guardrail around the porch.
- 6. Guidelines recommend window and door styles be similar, with similar proportions and ratio of solid to void, to historic houses on the block. Overall, the design includes a significant amount of windows on the façade and side elevations. The Board may choose to discuss the two fixed small windows closest to the street on the right side elevation.
- 7. The roof pitch and material are appropriate within the guidelines.
- 8. The final siding selection should be a smooth-finished, lap siding with a 4-5" exposure, compatible with the neighborhood context.
- 9. Final site plan should show a new native or naturalized shade tree to be planted in the front and rear yards.

Recommendation

Staff recommends approval of Certificate 4-C-23-IH, subject to the following conditions: 1) revision to front setback to align with adjacent houses; 2) porch columns to be increased to 8 by 8; 3) final site plan to meet City Engineering standards; 4) final site plan to include native or naturalized shade trees to be planted in front and rear yards.

Page 3 of 3 Planner in Charge: Lindsay Crockett 4-C-23-IH 4/6/2023 10:23:00 AM




INFILL HOUSING REVIEW BOARD

APPLICATION FOR CERTIFICATE OF APPROPRIATENESS

0 Chickamauga Ave.

Oakwood/Lincoln Park Infill Housing Overlay District

Original Print Date: 4/3/2023 Revised: Knoxville/Knox County Planning - Infill Housing Design Review Committee

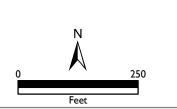

Authentisign ID: \$76D\$8D4-BECGED11-BA77-14CB652F4F5B Ir convenience. (2) Sign the application digitally (or print, sign, and scan). (3) Either print the completed form and bring it to the Knoxville-Knox County Planning offices or email it to applications@knoxplanning.org.


Planning KNOXVILLE I KNOX COUNTY

DESIGN REVIEW REQUEST

	\square DOWNTOWN DESIGN (DK)		
Planning	☐ HISTORIC ZONING (H)		
KNOXVILLE KNOX COUNTY	■ INFILL HOUSING (IH)		
Josh Braden			
Applicant			
03/24/23	April 19, 2023	4-C-	-23-IH
Date Filed	Meeting Date (if applicable)	File No	umber(s)
CORRESPONDENCE			
	application should be directed to the app		
	Engineer		
Josh Braden		den Family Properties, LLC.	
Name		npany	27024
303 Bob Smith Lane		oxville TN	37924
Address	City	State	Zip
865.696.7343	joshuabradens4@gmail.com		
Phone	Email		
CURRENT PROPERTY	INFO		
Same			
Owner Name (if different from app	plicant) Owner Address		Owner Phone
0 Chickamauga Avenue		081BK01101	
Property Address		Parcel ID	
Linwood Second Add			
Neighborhood		Zoning	
AUTHORIZATION			
Linday Crocke Staff Signature	th Lindsay Crockett		3.29.23
Staff Signature	Please Print		Date
Authentision			
Josh Braden	Josh Braden		03/24/23
Applicant Signature	Please Print		Date

REQUEST

DOWNTOWN DESIGN	Level 1: Signs Alteration of an existing building/structure Level 2: Addition to an existing building/structure Level 3: Construction of new building/structure Site design, parking, plazas, landscape See required Downtown Design attachment for more details. Brief description of work:				
HISTORIC ZONING D	Level 1: Signs Routine repair of siding, windows, roof, or other features, in-kind; Installation of gutters, storm windows/doors Level 2: Major repair, removal, or replacement of architectural elements or materials Additions and accessory structures Level 3: Construction of a new primary building				
INFILL HOUSING	Level 1: Driveways, parking pads, access point, garages or similar facilities Subdivisions Level 2: Additions visible from the primary street Changes to porches visible from the primary street Level 3: New primary structure Site built Modular Multi-Sectional See required Infill Housing attachment for more details. Brief description of work:				
STAFF USE ONLY	ATTACHMENTS Downtown Design Checklist Historic Zoning Design Checklist Infill Housing Design Checklist ADDITIONAL REQUIREMENTS Property Owners / Option Holders Level 1: \$50 • Level 2: \$100 • Level 3: \$250 • Level 4: \$500	FEE 1: FEE 2: FEE 3:	TOTAL:		

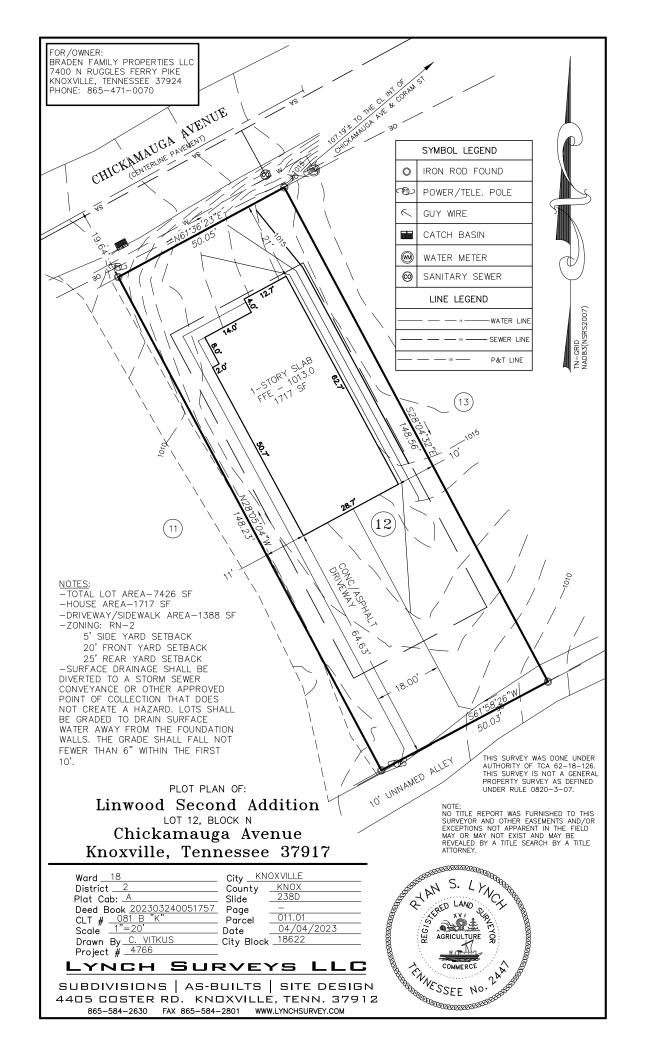





New One Story Single Family Residence

Brought to you by Braden Family Property LLC









Front Elevation

Scale: 1/4" = 1'-0"

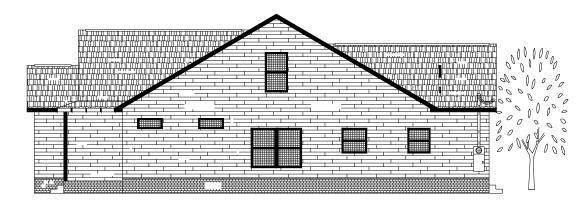


Right Side Elevation
Scale: 1/4" = 1'-0"

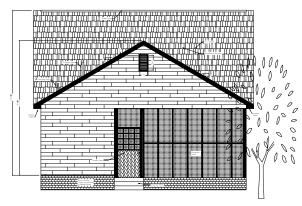

Rear Elevation

Scale: 1/4" = 1'-0"

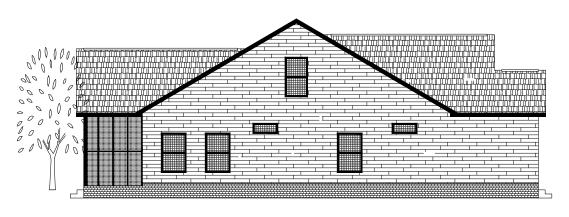

Left Side Elevation

Scale: 1/4" = 1'-0"


New One Story Single Family Residence

Sheet C1-0



Front Elevation

Scale: 3/8" = 1'-0"

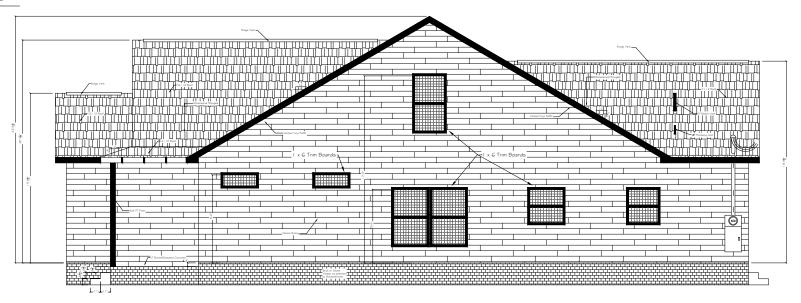


Right Side Elevation


Scale: 3/8" = 1'-0"

New One Story Single Family Residence

Sheet C1-1

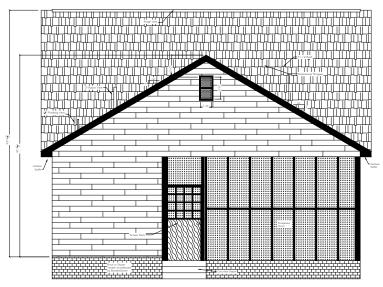

Rear Elevation

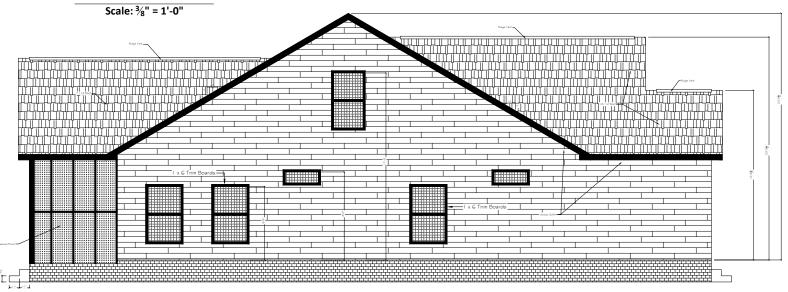


Left Side Elevation

New One Story Single Family Residence

Scale: 3/8" = 1'-0"

Sheet C1-2

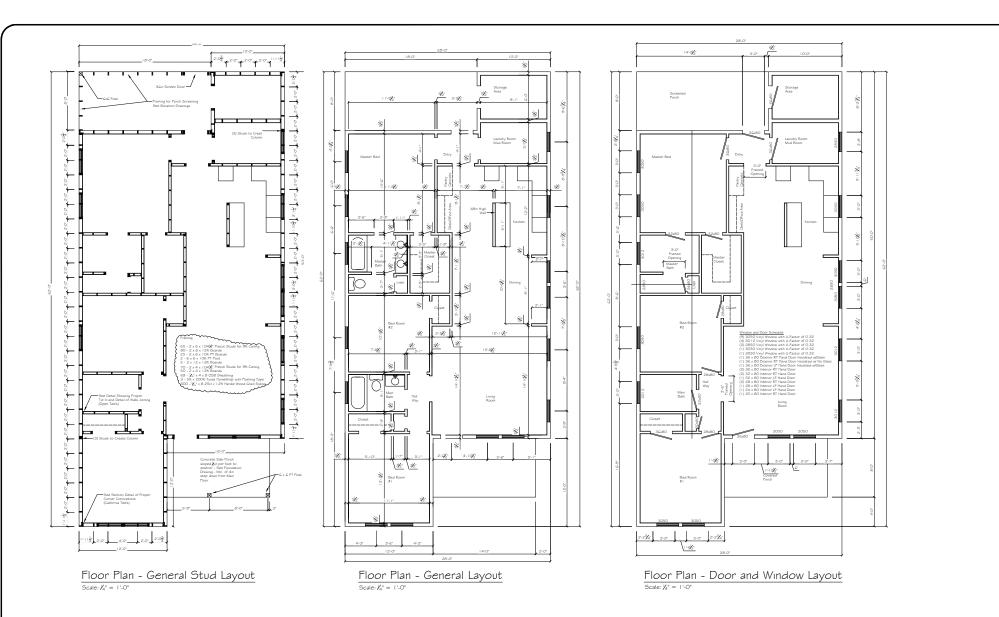

Project Name and Address	Project Number	Sheet Number
New One Story Single Family Residence	2021-P002	Sheet Number
	Drawing Date	1
	August 8, 2021	1A2 ()
Contractor	Scale:	12.0
Josh Braden, Affiliate Broker	See Drawing Layout	1
Braden Family Property LLC Cell: 865-696-7343		
Office: 865-471-0070		