

DESIGN REVIEW REQUEST

DOWNTOWN DESIGN (DK)
HISTORIC ZONING (H)
INFILL HOUSING (IH)

RECENSE JAN 3 (2020 Knoxville-Knox Course Planning

J. Scott Busby, AIA

Applicant

01/31/2020

Date Filed

02/19/2020 Meeting Date (if applicable)

2-6-20-DT

File Number(s)

CORRESPONDENCE

All correspondence related to this application should be directed to the approved contact listed below.

🗌 Owner	Contractor	🗋 Engineer	Architect/Landscape A	rchitect		
Scott Busby, AIA				Smee + Busby Arcl	nitects, P.C.	
Name				Company		
2554 Sutherland Avenue				Knoxville,	TN	37919
Address				City	State	Zip
(865) 521-7550		sbusby@smeebusby.com	ì			
Phone		Email				

CURRENT PROPERTY INFO

115 S. Central LLC, Leigh Burch/Mark Jernigan	122A South Gay Street, Knoxville, TN 37902	(865) 384-3426	
Owner Name (if different from applicant)	Owner Address	Owner Phone	
117 S. Central Knoxville, TN 37902	094EG017		
Property Address	Parcel ID		
Old City/Crown and Goose Final Plat	DK-W		
Neighborhood	Zoning		

AUTHORIZATION

Staff Signature

Applicant Signature

Michael Reynolds Please Print

J. Scott Busby, AIA

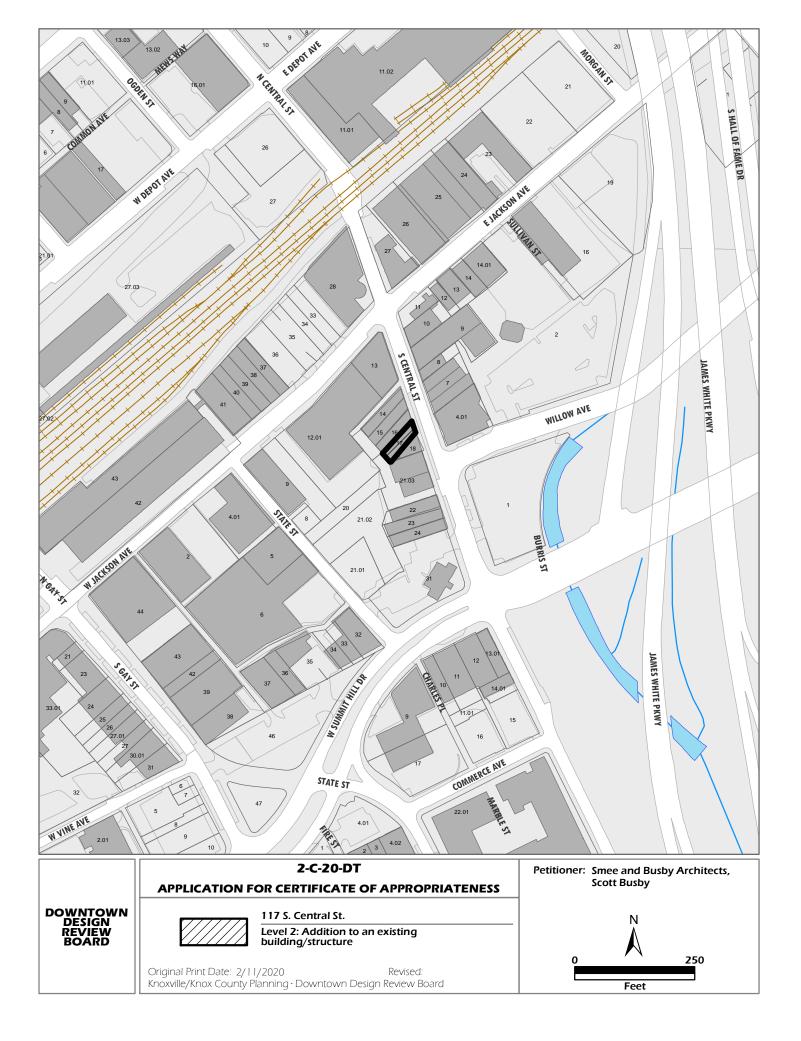
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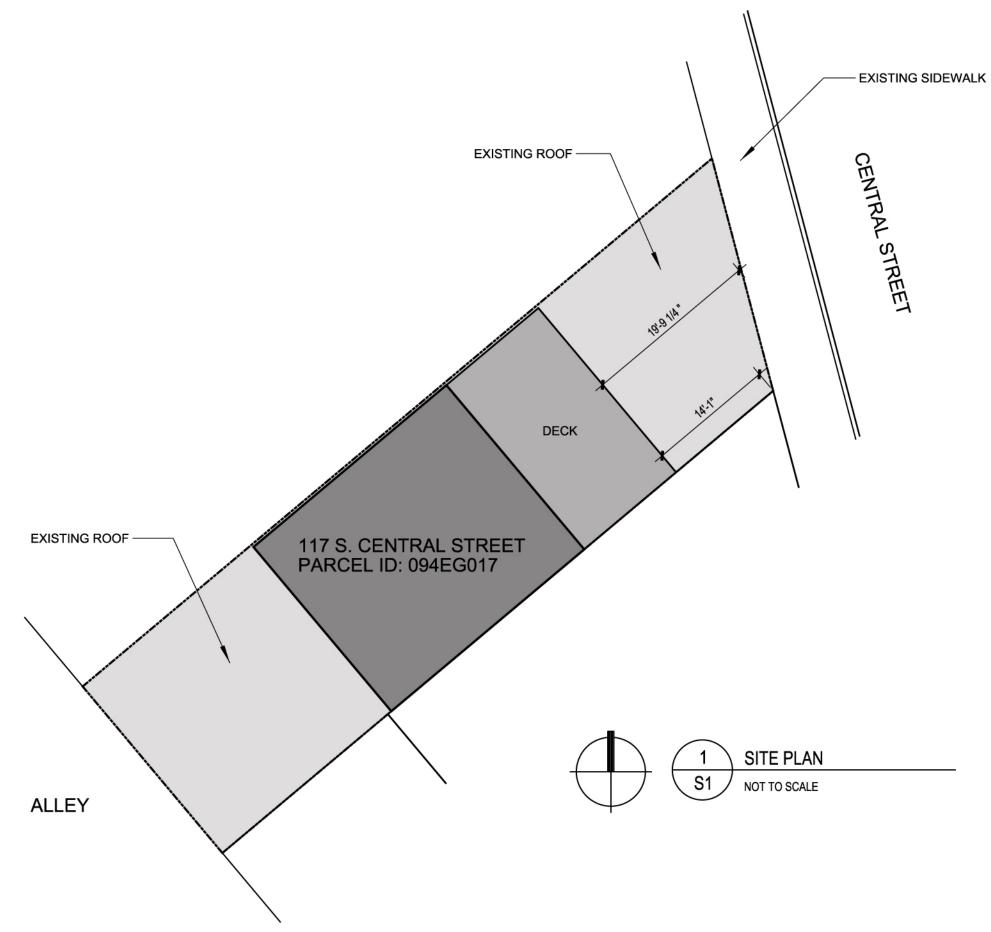
01/31/2020

Date

REQUEST

DOWNTOWN DESIGN	Level 1: Signs Alteration of an existing building/structure Level 2: Addition to an existing building/structure Level 3: Construction of new building/structure Site design, parking, plazas, landscape See required Downtown Design attachment for more details. Brief description of work: Addition of 730 sf roof top enclosed bar with covered deck. New steel stair from existing space will access rooftop. Space to have a max capacity of 49 occupants. Enclosure to be set back from Central Street facade. All materials to be non-combustible.
HISTORIC ZONING	Level 1: Signs Routine repair of siding, windows, roof, or other features, in-kind; Installation of gutters, storm windows/doors Level 2: Additions and accessory structures Level 3: Additions and accessory structures Level 4: Demolition of a contributing structure Beref 4: Demolition of a contributing structure Brief description of work: Brief description of work:
INFILL HOUSING	Level 1: Driveways, parking pads, access point, garages or similar facilities Subdivisions Level 2: Additions visible from the primary street Changes to porches visible from the primary street Level 3: New primary structure Site built Modular Multi-Sectional See required Infill Housing attachment for more details. Brief description of work:
	ATTACHMENTS FEE 1: TOTAL: Downtown Design Checklist 100.90 100.90 Historic Zoning Design Checklist FEE 2: 100.90 Infill Housing Design Checklist FEE 2: 100.90 ADDITIONAL REQUIREMENTS FEE 3: 100.90
	Level 1: \$50 • Level 2: \$100 • Level 3: \$250 • Level 4: \$500



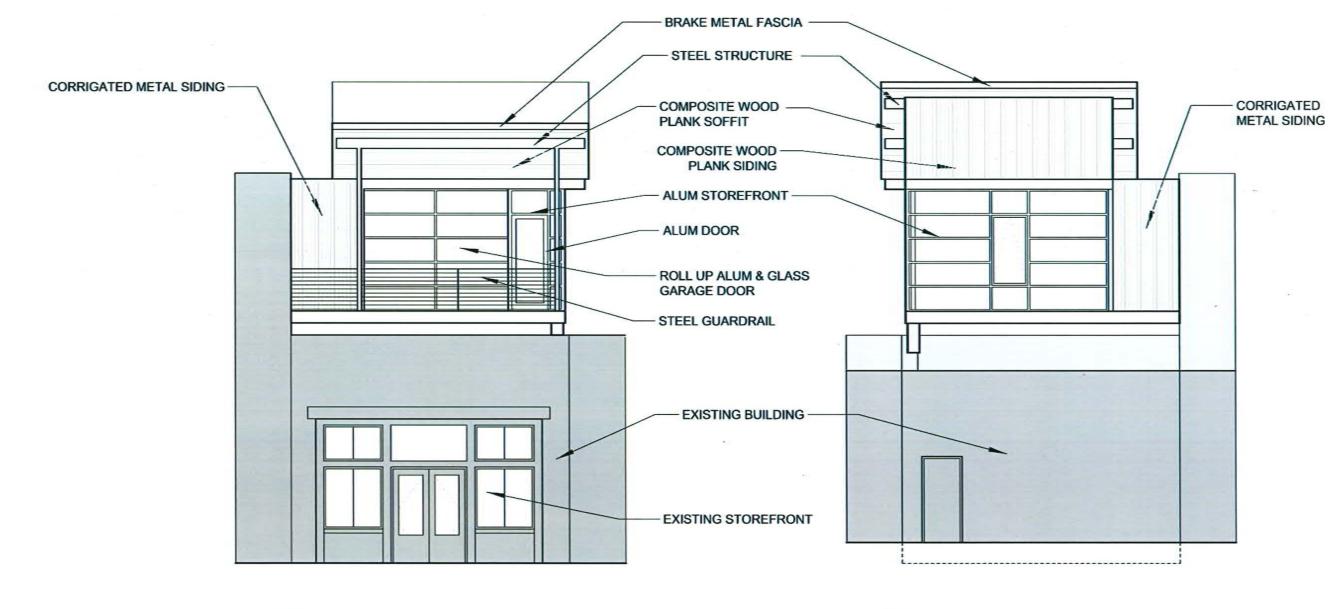




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Site Plan



(1	FRONT	ELE	EVA	TION		
(A2	1/8" = 1'-0"	0	2	4	8'	





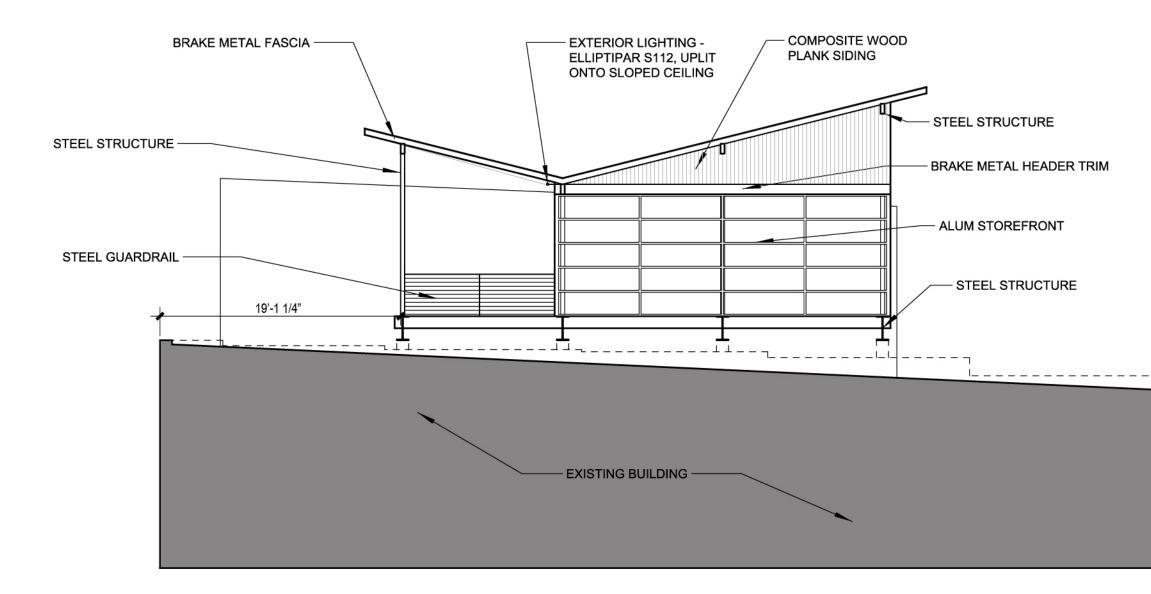
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Project Number: 1 Issue Date: 01.3	
Drawn By:	СК
Approved By:	SB
Project Manager:	CK
Principal:	SB

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> Front & Rear Elevations

A2







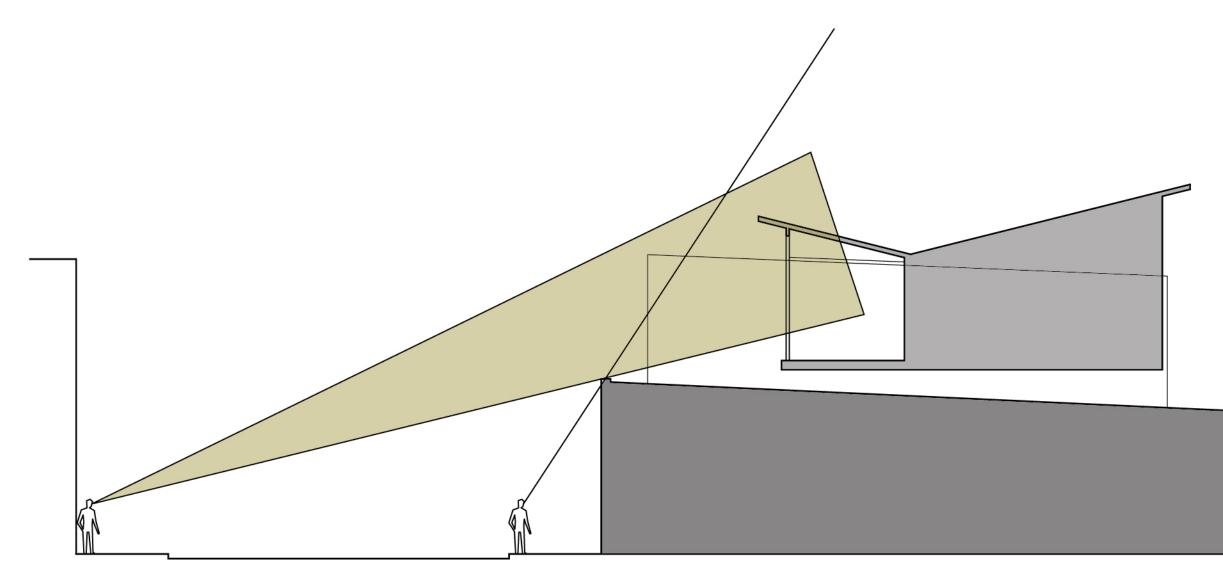
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Project Manager:	ск
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Side Elevation





$\begin{pmatrix} 1 \end{pmatrix}$	STREET SECTION DIAGRAM
$\boxed{A3}$	NOT TO SCALE



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Project Number: 1 Issue Date: 01.3	9029 31.20
Drawn By:	ск
Approved By:	SB
Project Manager:	ск
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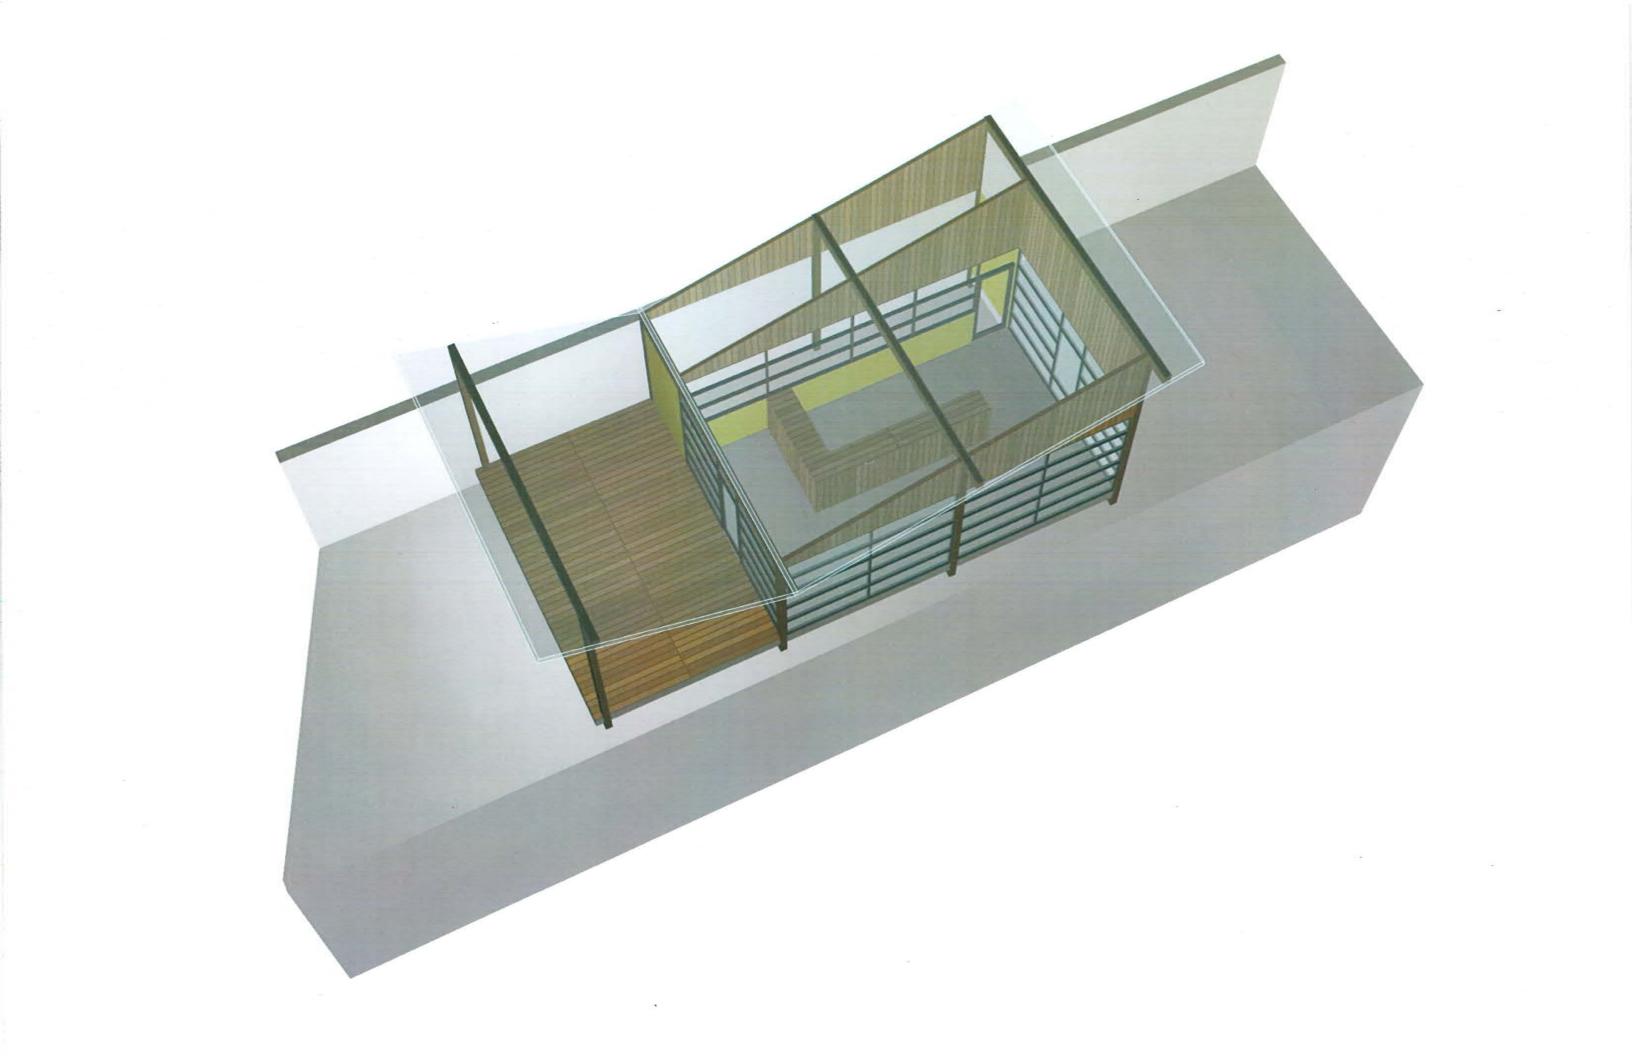
Street Section Diagram

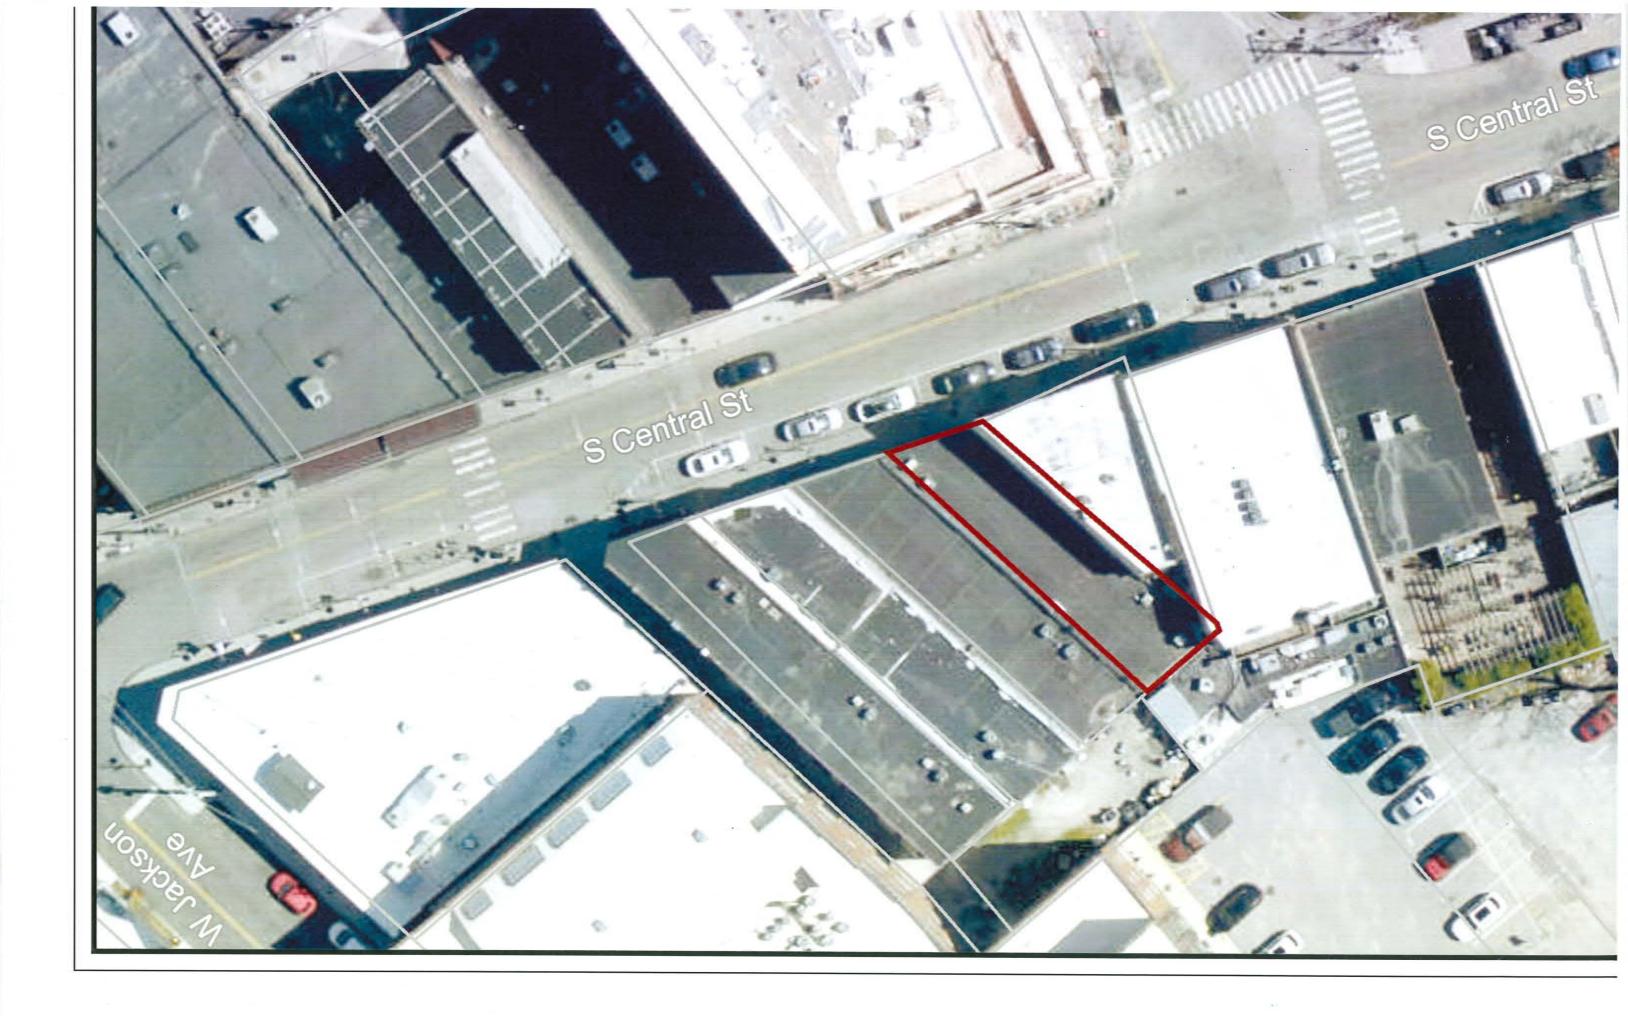
2-C-20-DT Revised: 3/6/2020



2-C-20-DT Revised: 3/6/2020

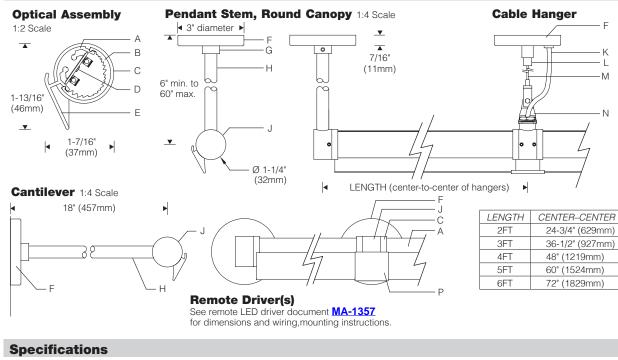
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Lighting the Wall Xtra small linear, remote driver

Style S112



- A Extruded aluminum heat sink/housing
- В Extruded semi-diffuse lens
- **C** Die-cast aluminum end plate 1-1/8" dia.
- **D** Linear LED PCB with mid-power LEDs E Integral visor (extruded aluminum)
- F Aluminum canopy (3" dia. x 7/16" D)

Housing and Optic Assembly:

Extruded aluminum heat sink/optic housing. Exterior heat sink anodized for maximum emissivity. Precision extruded polymer refractive lens with optimal dispersion.

Finish:

Bright anodized extruded aluminum heat sink/housing with painted finish, white or black. Formed aluminum canopy, end hubs and stems painted white or black.

Painted surfaces - 6 stage pretreatment and electrostatically applied thermoset polyester powder coating for a durable abrasion, fade and corrosion resistant finish. All hardware - stainless steel or nickel plated brass.

Mounting:

Required cable, pendant or cantilever mounting hangers ordered and priced separately; see pg. SW24.1. Specify end and intermediate hangers as needed. Cantilever/pendant supplied with recessed outlet box (suitable backing structure required). Adjustable interface plate (concealed under canopy) allows for leveling of arms.

Fixture weight: 0.8 lb/ft (1.1 kg/m).

K Cord to remote driver

Electrical:

G Slip ring with set screw

pendant stem 1/2" O.D.

J Aluminum mounting hub

H Extruded aluminum

Units are furnished with 10 foot (3048mm) leads for connection to remote driver Class II output. Remote electronic HPF thermally protected Class II driver mounted in aluminum enclosure. For complete driver specifications, see website, reference document MA-1303. Optional, compatible dimming controls (by others). See website for dimming compatibility and specifications.

L Cable coupler with slip ring

N Cable gripper and leveling

M 1/16" dia. 7x7 cable

Standard:

UL listed or CSA certified for damp location. 5 year warranty, maximum ambient temperature 45°C (113°F).





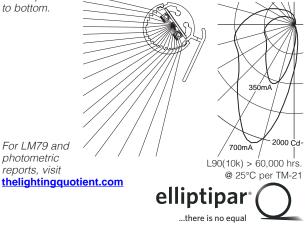
Features

- Inconspicuous low profile lights entire wall evenly without emphasizing surface imperfections (unlike slot grazers)
- Built-in visor provides shielding of glare from below
- Adjustable and lockable aiming
- Small, elegant hub hangers with pendant stem, cable, or cantilever mounting

Performance

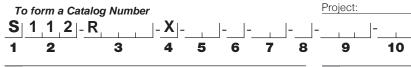
Precisely extruded acrylic lens produces an asymmetric distribution ideal for illuminating vertical surfaces evenly from top

to bottom.





bracket (ordered separately) **P** Extruded aluminum intermediate cover



1 Source

S = Solid state (LED)

2 Style

112 = Xtra small linear LED asymmetric, remote driver

3 Length / Light Output / Power

ORDER CODE	LENGTH	LUMENS	INPUT WATTS	NUMBER OF LEDS	DRIVE CURRENT
R02G	2FT	975	7	72	175mA
R02L	2FT	1911	13	72	350mA
R02M	2FT	3704	27	72	700mA
R03G	3FT	1462	10	108	175mA
R03L	3FT	2866	20	108	350mA
R03M	3FT	5555	40	108	700mA
R04G	4FT	1949	13	144	175mA
R04L	4FT	3821	27	144	350mA
R04M	4FT	7407	53	144	700mA
R05G	5FT	2437	17	180	175mA
R05L	5FT	4777	33	180	350mA
R05M	5FT	9259	67	180	700mA
R06G	6FT	2924	20	216	175mA
R06L	6FT	5732	40	216	350mA
R06M	6FT	11111	80	216	700mA



Based on 3500K/80+CRI. Click here for scaled performance table.

4 Mounting

X = For use with required cantilever, pendant stem, or cable hangers - ordered and priced separately; see at right

5 Finish

- 02 = Semigloss white
- 08 = Semigloss black
- **99** = Custom RAL or computer matched color to be specified. consult factory

6 Voltage

- Μ = 120-277V Universal voltage input
- Κ = 347V input

7 **Option** (See Accessories Section for specifications)

- **00** = No options
- **0B** = Cross baffle, provides 25° lateral shielding
- **OM** = For use in MRI medical facility. MRI filters required on output of each remote driver. Consult factory prior to specification.

8 **Destination Requirement**

- = UL listed or CSA certified for U.S. 0
- UL listed or CSA certified for Canada

9 Color Temperature / CRI

827 = 2700K, 80+ CRI	927 = 2700K, 90+ CRI
830 = 3000K, 80+ CRI	930 = 3000K, 90+ CRI
835 = 3500K, 80+ CRI	935 = 3500K, 90+ CRI
840 = 4000K, 80+ CRI	940 = 4000K, 90+ CRI

Note: Additional CCT and CRI options are available; consult factory.

10 Dimmina**

00 = Non-dimming

- **TD** = ERP Tri-Dim forward phase, reverse phase (120V) or 0-10V dimming (120-277V), 100-10% power on forward/ reverse phase, 100%-1% on 0-10V, compatible controls by others
- **ZX** = 0-10V analog dimming 120-277V input, dimming range 100%-5%, 0-10V controls by others
- EL = eldoLED SOLOdrive 120-277V input, 0-10V analog dimming 100%-0.1% power (controls by others)
- **ED** = eldoLED SOLOdrive 120-277V input, dimming range 100%-0.1%, DALI controls by others

**Dimming range refers to % power input, % light output will vary.

Refer to Driver Information document MA-1357

Note: Number of drivers varies with length and drive current see MA-1447

Required Mounting Hangers (X Mount)

Mounting hangers HMC, HMD, HMF, HMG, or HMP are required for the S112 — ordered and priced separately. See installation sheets on website. For individually mounted luminaires, order two end hangers for each housing. For a continuous row, order two end hangers. To determine the quantity of intermediate hangers, total the number of housings in the row and subtract one. Example: a row of 5 housings requires 2 end hangers and 4 intermediate hangers.

- **HMC** Cantilever hanger with round canopy, intermediate
- HMD Cantilever hanger with round canopy, end
- **HMF** Pendant stem with round canopy, intermediate
- HMG Pendant stem with round canopy, end
- HMP Cable hanger with round canopy, feed, non-feed

Accessories

Type:

Order separately. See Accessories Section for specifications.

AMR02050 = Accessory Magnetic Resonance imaging filter. 2 conductor up to 5 amps, attenuation > 100dB

Note: one filter required per remote driver consult factory for number of drivers required per luminaire.

AXC0899 = Accessory plug and socket guick connectors for use with #18/2 AWG solid or topcoat wire by others to extend

remote driver distance

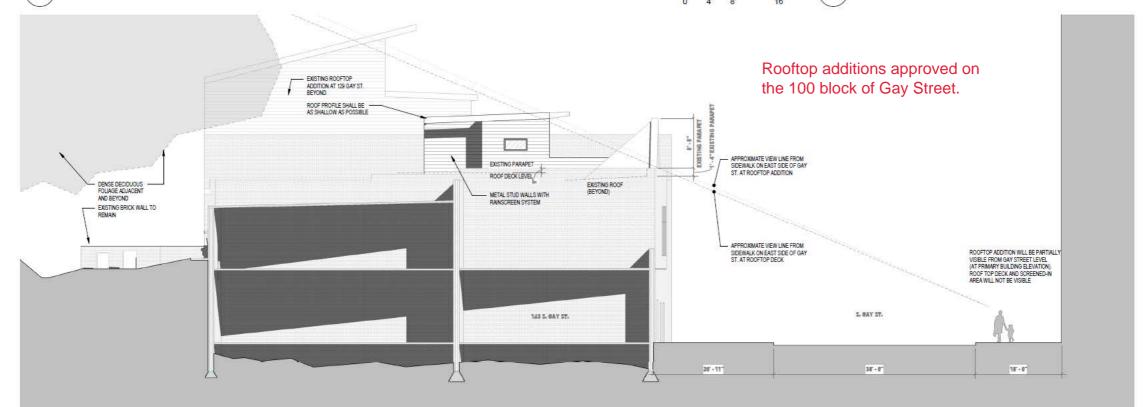




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(5MHz to 10GHz).



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