Dow	KNOXVILLE-KNOX COUNTY
Ce	METROPOLITAN
Name of	P L A N N I N G C O M M I S S I O N
	TENNESSEE
□ Owne	Suite 403 • City County Building 4 0 0 Main Street

LEVEL 3: \$250

□ Construction of New Building/Structure

# ntown Knoxville Design Overlay District rtificate of Appropriateness

COMMISSION Name of Applicant:			
TENNESSEE Suite 403 • City County Building Owner Contractor Architect Engineer Other			
400 Main Street Knoxville, Tennessee 37902 865 • 215 • 2500 Date Filed: Appli	cation accepted by:		
F A X • 2 1 5 • 2 0 6 8	Date: File Number:		
PRE-APPLICATION CONFERENCE	Date Completed:		
PROPERTY INFORMATION	PROJECT ARCHITECT/ENGINEER		
Building or Project Name:	PLEASE PRINT Name:		
	Company:		
Street Address:	Address:		
Parcel Identification Number(s):	City: State: Zip:		
	Telephone:		
PROPERTY OWNER	Fax:		
PLEASE PRINT Name:	E-mail:		
Company:	PROJECT CONTRACTOR		
Address:	PLEASE PRINT Name:		
City: State: Zip:	Company:		
Telephone:	Address:		
Fax:	City: State: Zip:		
E-mail:	Telephone:		
ACCOMPANYING MATERIALS	Fax:		
Please see the reverse side of this form for a list of information required as part of this application.	E-mail:		
FOR OFFICE USE ONLY	PROJECT CONTACT		
PROJECT INFORMATION	All application-related correspondence should be directed to:		
LEVEL 1: \$50	PLEASE PRINT		
<ul> <li>Minor Alteration of an Existing Building/Structure</li> <li>Sign</li> </ul>	Name:		
	Company: Address:		
LEVEL 2: \$100			
Addition to an Existing Building/Structure	City: State: Zip:		

NOTE: Payment is due at time of application. Please make check payable to Knoxville Knox County Metropolitan Planning Commission.

E-mail: \_\_\_\_

Telephone: \_\_\_\_\_

Fax: \_\_\_\_\_

#### **ACCOMPANYING MATERIALS**

All applications must be accompanied by a written description of the request(s). The description may be brief but must include information on existing conditions and each element of the overall project. We require one (1) paper copy and one (1) PDF file OR 10 paper copies of ALL printed materials. A graphic scale is required for all scaled drawings.

# LEVEL 1:

#### SIGNS:

- 1. Scaled drawings for proposed signs
  - a. Drawings for wall signs should include a scaled drawing of the facade(s) on which the signs will be placed.
  - b. For free-standing signs, a site plan should include the location of signs and the relationship to existing buildings and other site features on the property.
- 2. Fully labeled color photographs of the property and surrounding properties
- 3. A list of proposed materials and colors, including manufacturer's specifications.
- 4. Information illustrating the design and type of lighting, if any.

# LEVEL 1 & LEVEL 2:

# ALTERATION OF AN EXISTING BUILDING/STRUCTURE:

- 1. Scaled drawings, or a written narrative for simpler projects, indicating the extent of the proposed alteration.
- 2. Fully labeled color photographs of the property, with detailed photos of any existing elements that you wish to change.
- 3. A list of proposed materials.
- 4. Other information needed to explain your request such as labeled photos of existing elements that you wish to imitate from the subject property or any other property.

## LEVEL 2:

## ADDITION TO AN EXISTING BUILDING/STRUCTURE:

- 1. Site Plan, indicating the extent of the proposal and its relationship to any existing structures on the property and neighboring properties, as well as the relationship to property lines.
- 2. Building elevations for all sides. Drawings for additions should illustrate the relationship to the existing structure. Drawings should show the relationship to buildings on the property and adjacent lots.
- 3. Fully labeled color photographs of the property, with detailed photos of any existing elements that you wish to change.
- 4. A list of proposed materials.
- 5. Information illustrating the design and type of lighting and trim details.
- 6. Other information needed to explain your request such as labeled photos of existing elements that you wish to imitate from the subject property or any other property.

# LEVEL 3:

# CONSTRUCTION OF NEW BUILDING/STRUCTURE:

- 1. Site Plan, indicating the extent of the proposal and its relationship to any existing structures on the property and neighboring properties, as well as the relationship to property lines.
- 2. Building elevations for all sides. Drawings should show the relationship to buildings on the property and adjacent lots.
- 3. Fully labeled color photographs of the property, with detailed photos of any existing elements that you wish to change.
- 4. A list of proposed materials.
- 5. Information illustrating the design and type of lighting and trim details.
- 6. Other information needed to explain your request.


# LEVEL 3:

#### SITE DESIGN, PARKING, PLAZAS, LANDSCAPE:

- 1. Site Plan, indicating the extent of the proposal and its relationship to any existing structures on the property, streets, public property, and any structures on immediate adjacent lots.
- 2. Landscape plan, indicating species and planting sizes, irrigation, lighting location and detail, hardscape materials and colors
- 3. Fully labeled color photographs of the property and surrounding properties
- 4. Information illustrating the design and type of lighting and other design elements.

#### NOTE: Demolition Of An Existing Building/Structure

Please check with local H-1 or National Register Districts before considering demolition of an existing structure.

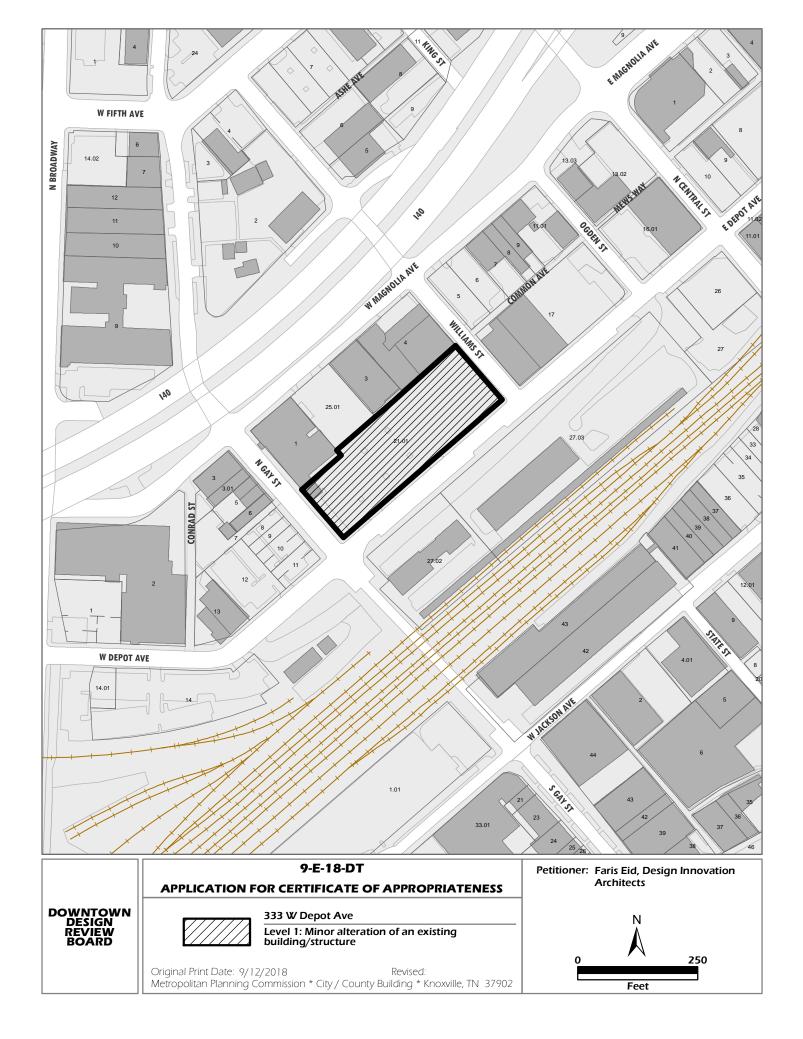



September 12, 2018

Knoxville Knox County Metropolitan Planning Commission 400 Main St., Suite 403 Knoxville, TN 37902

Re: East revisions at first floor: DIA Project Number: 14018 File No. R18-0658

Dear Mike Reynolds,

We are making a revision to the first-floor east side of Regas Square, by expanding the interior footprint to a location that is still within the soffit above this area. Therefore, the overall building footprint does not change. The exterior building material and relationship between the different components is still relatively the same.

The wall that got moved to the east is 15'-2" away from the property line. The front doors are anticipated and planned to be at the front of the building, but that is subject to a future tenant design work, when the space is leased. The new back door is anticipated to be a future service access door. The reason for the wall without windows, facing east, is that it is anticipated that this will be the location of a future kitchen.

Project code information, life safety plan, floor plans, reflected ceiling plan, elevations, opening schedule and glazing elevations were updated to reflect the changes. New wall section 5/A355 was added.

Sincerely, Design Innovation

(Signature)


Maria Ortiz, Assoc. AIA Intern Architect

(Printed Name and Title)


EC: Faris Eid, Aaron Miller, Greg Campbell, file; Design Innovation


Page 1 of 1


Excellence through service and design

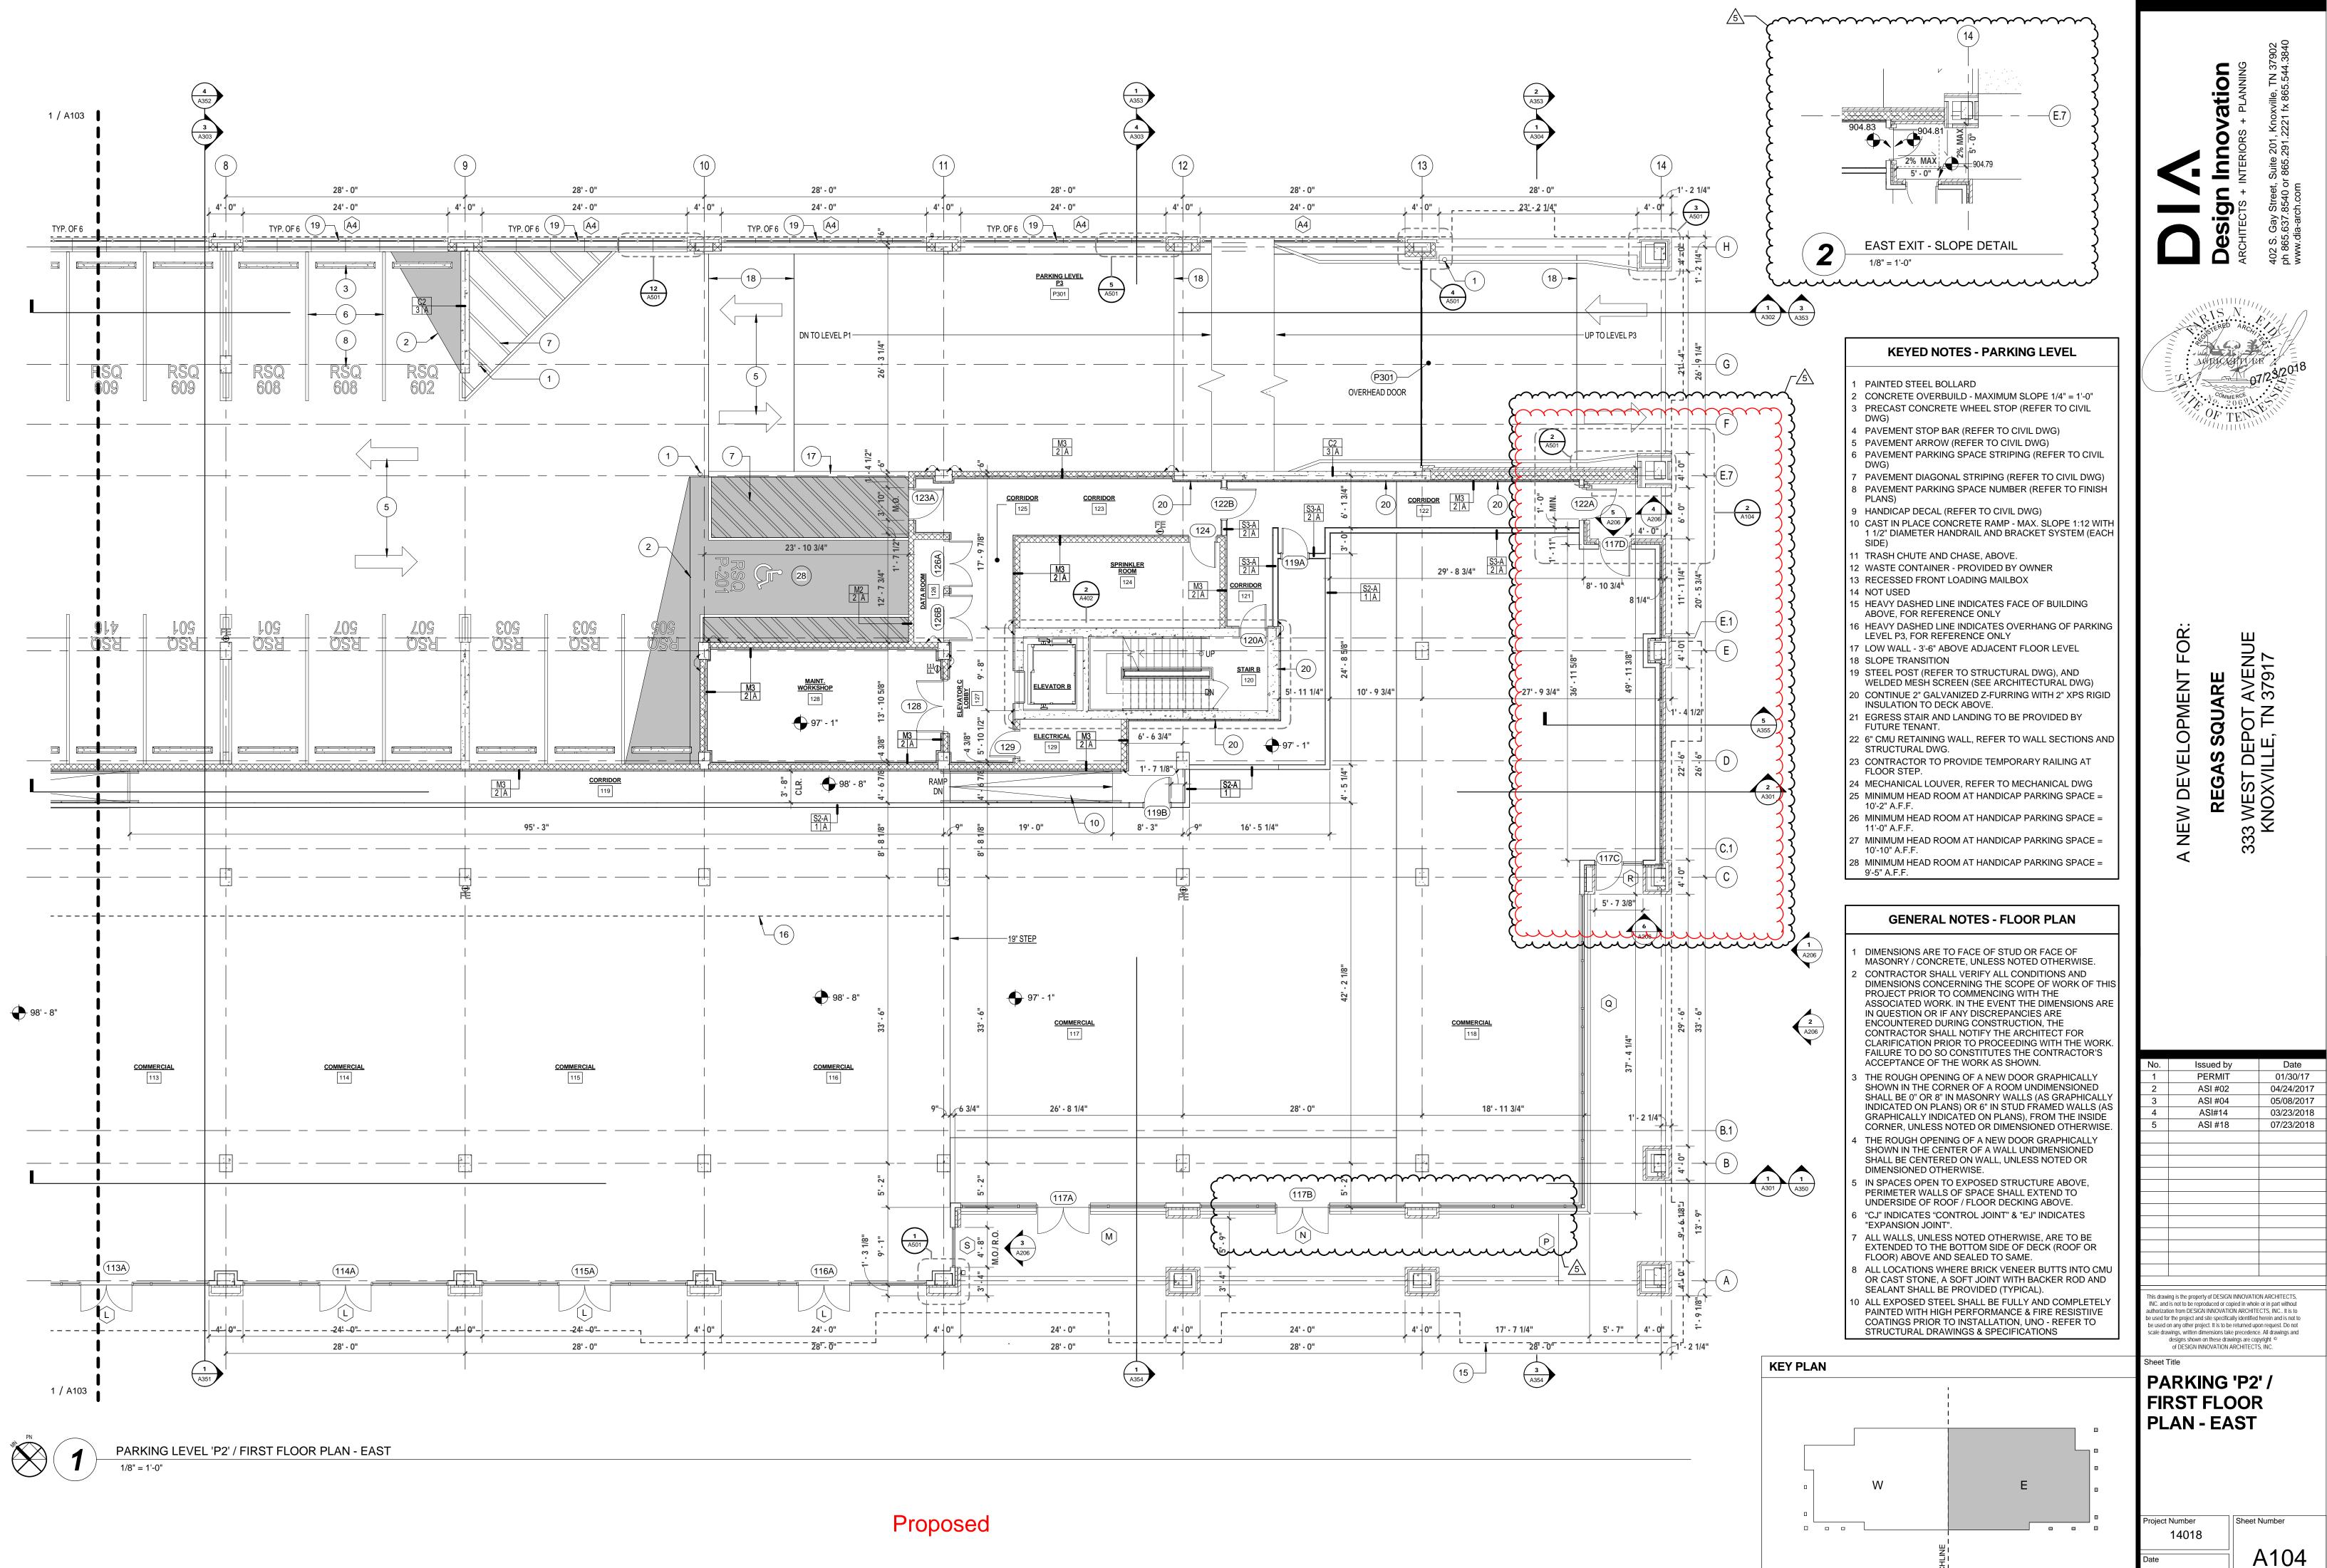

01/30/17

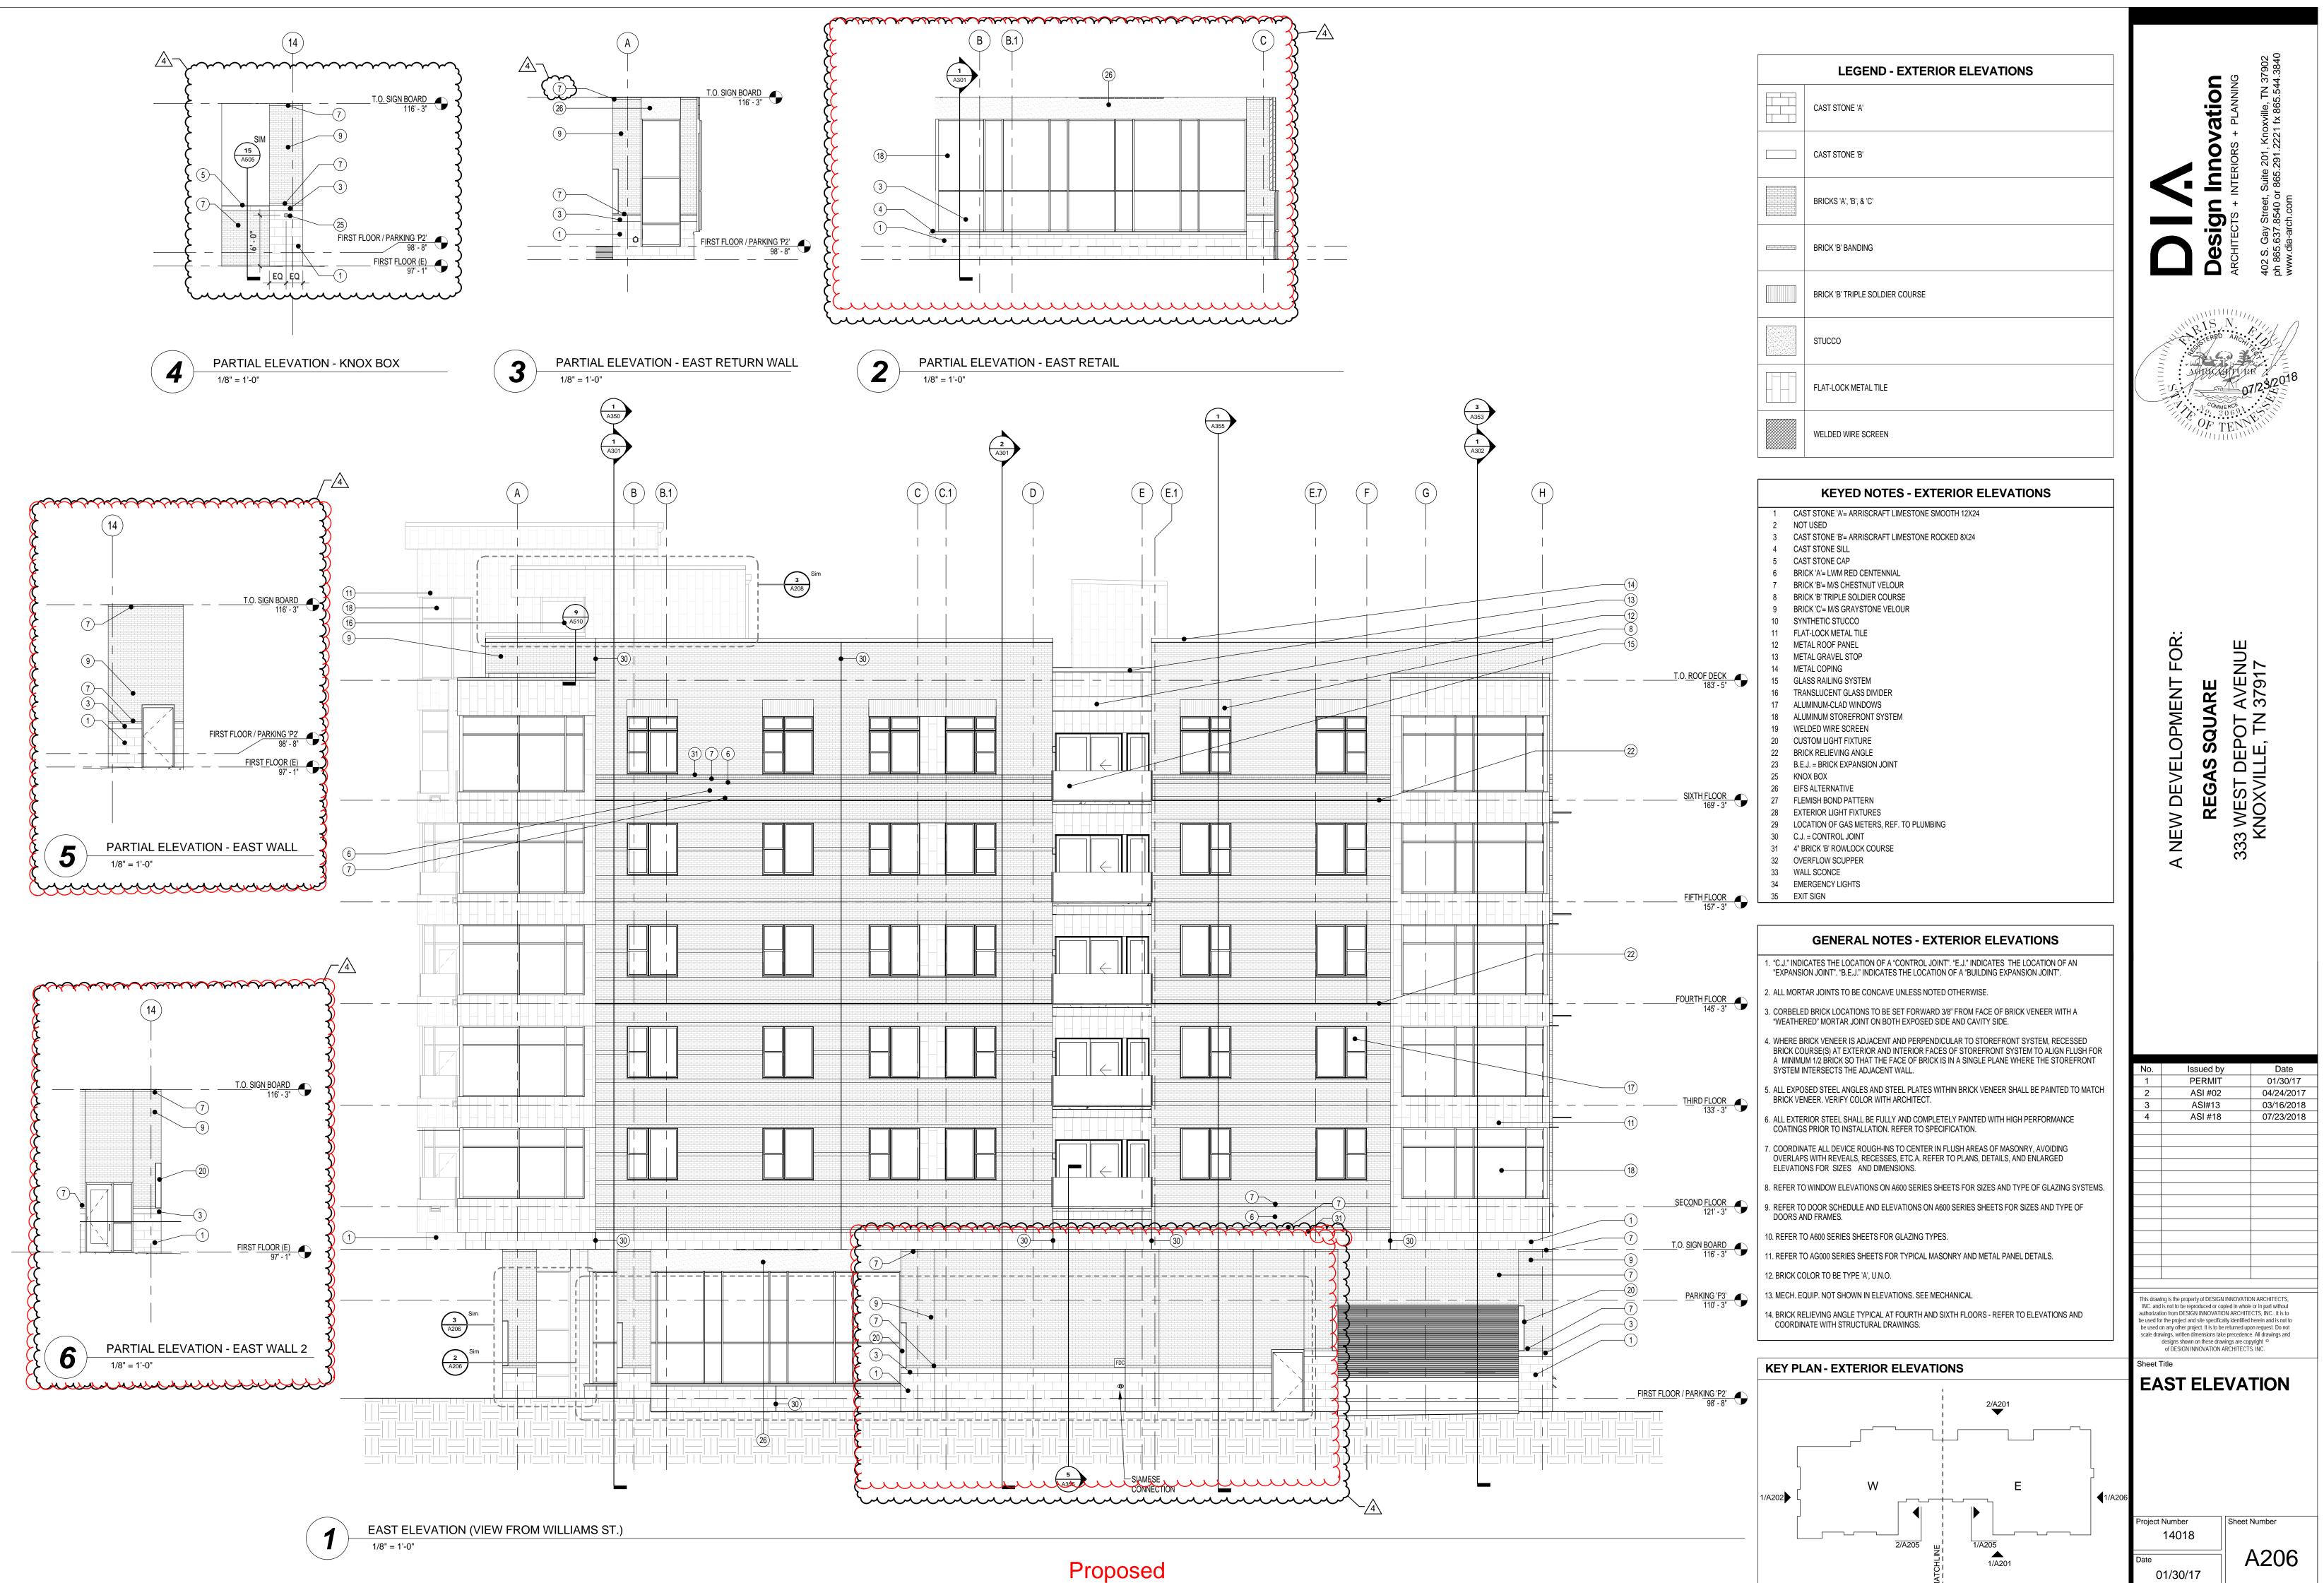

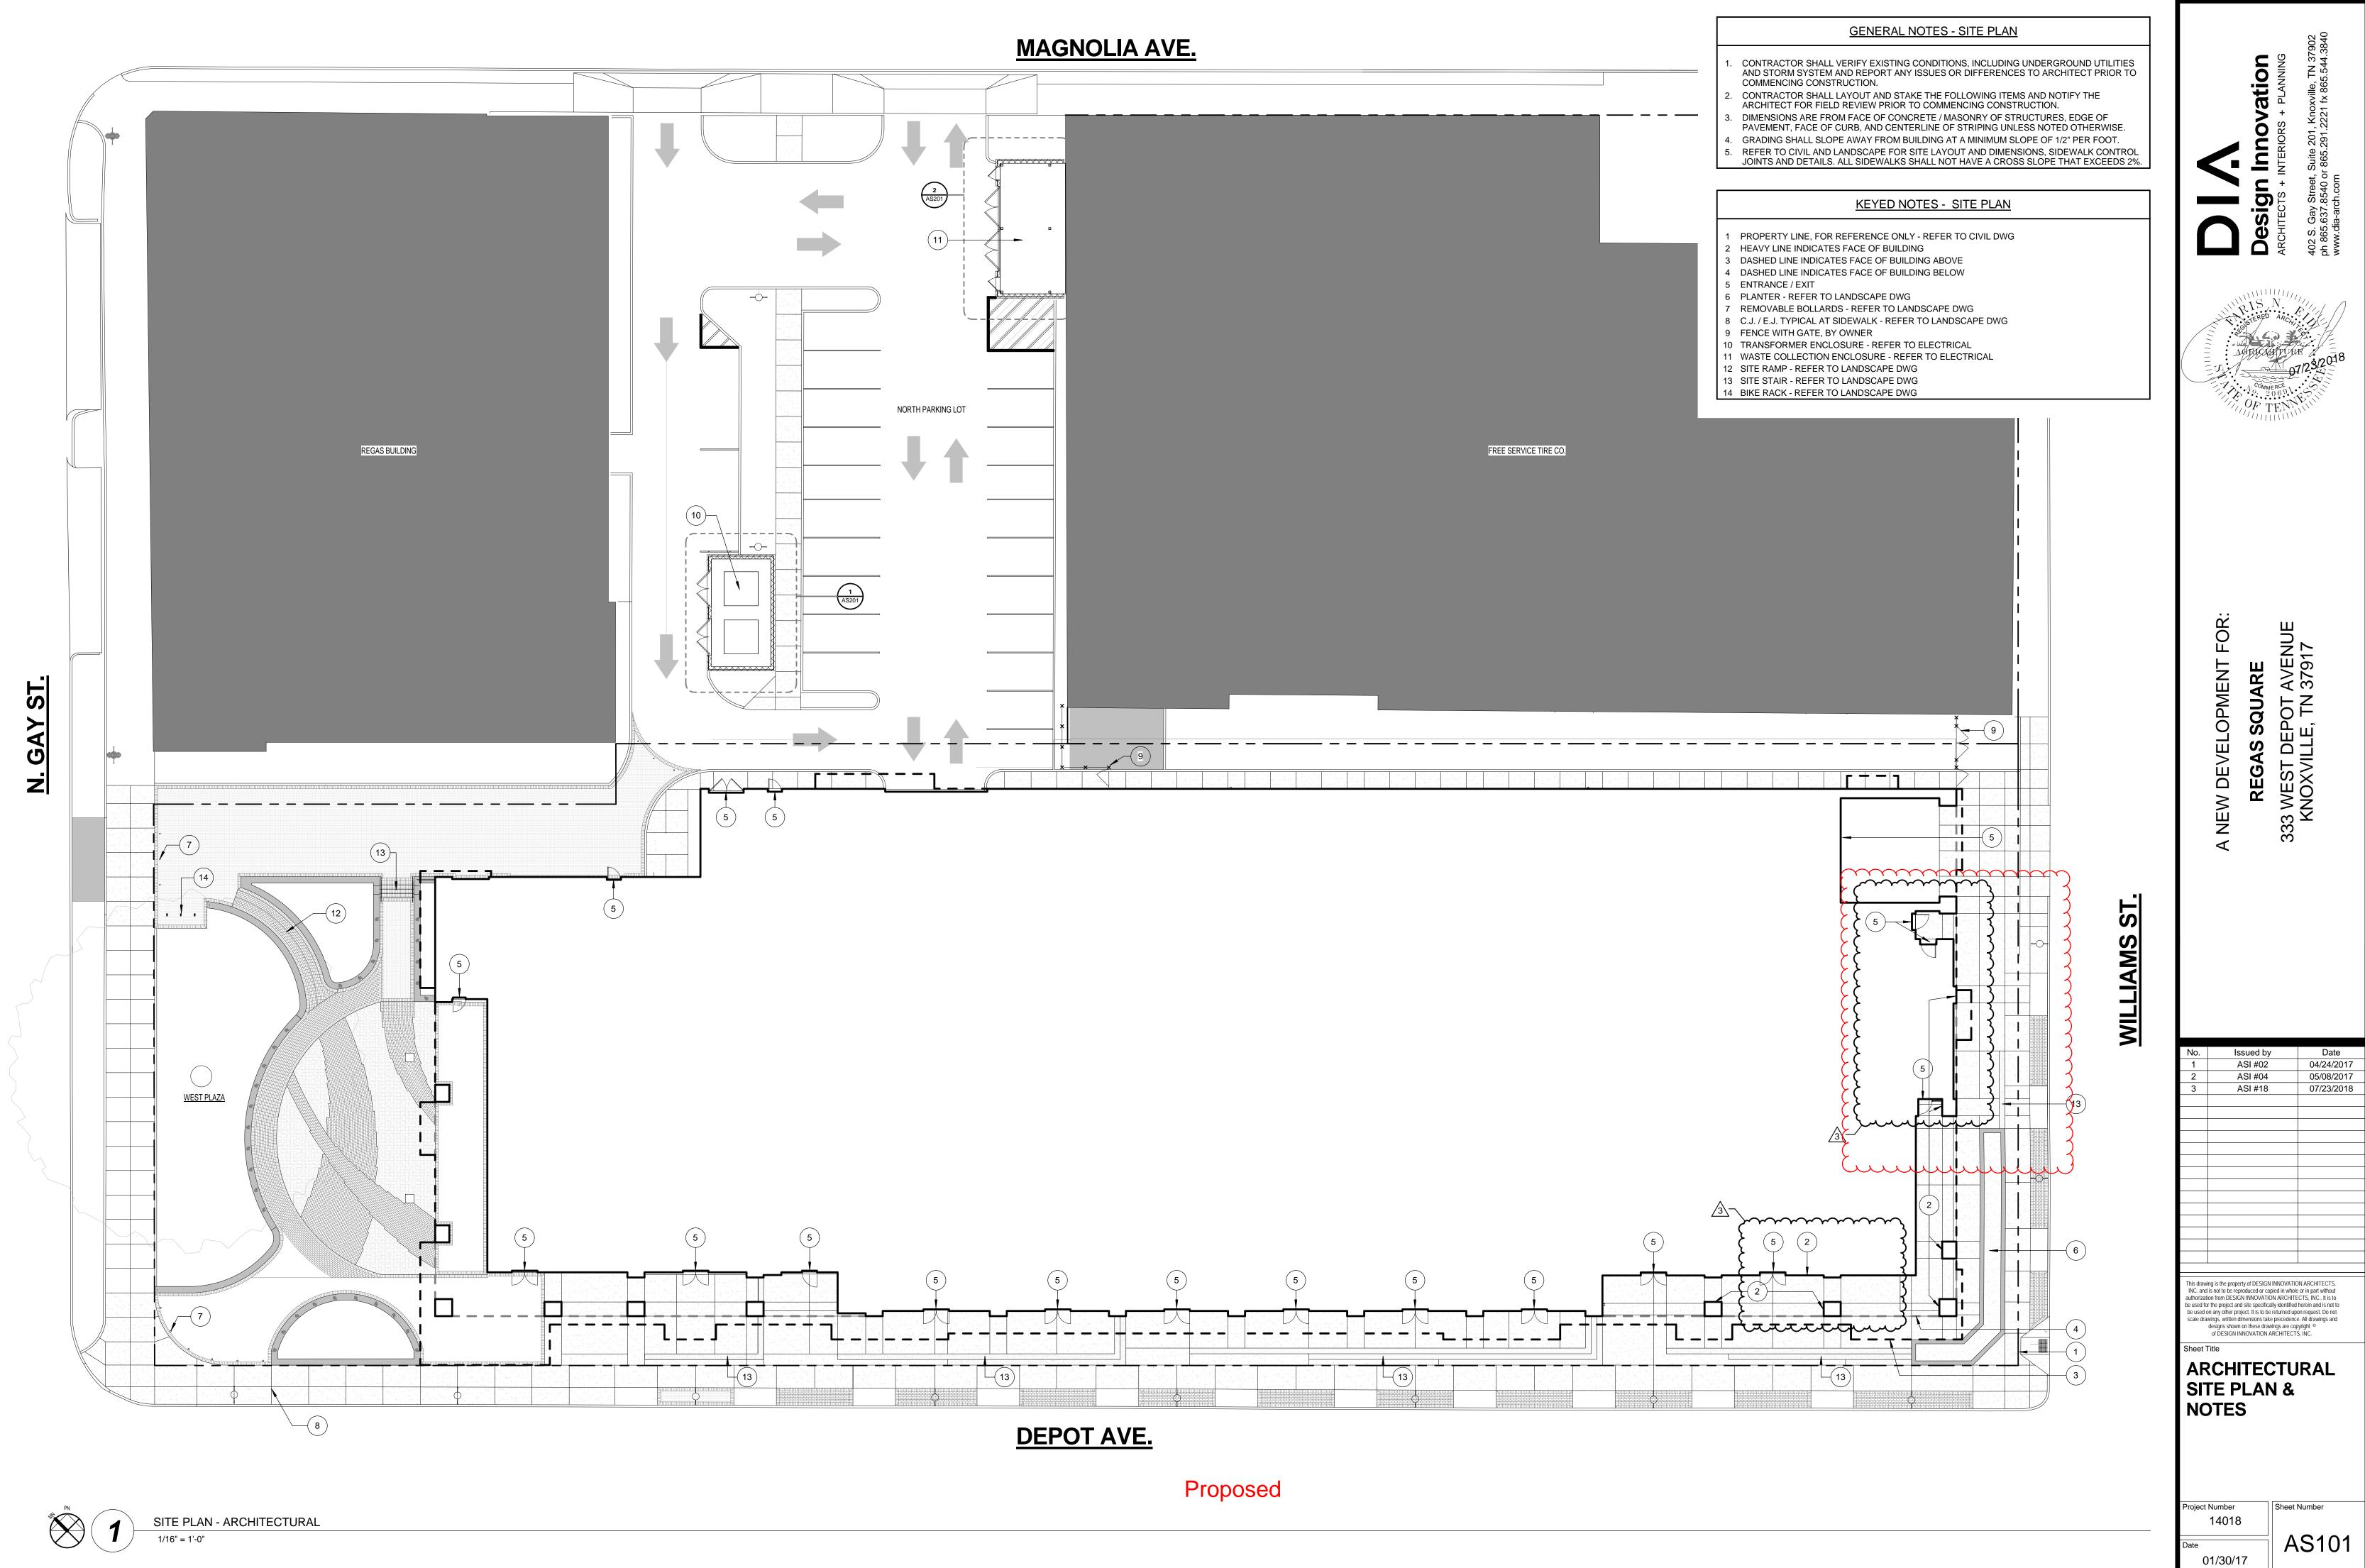

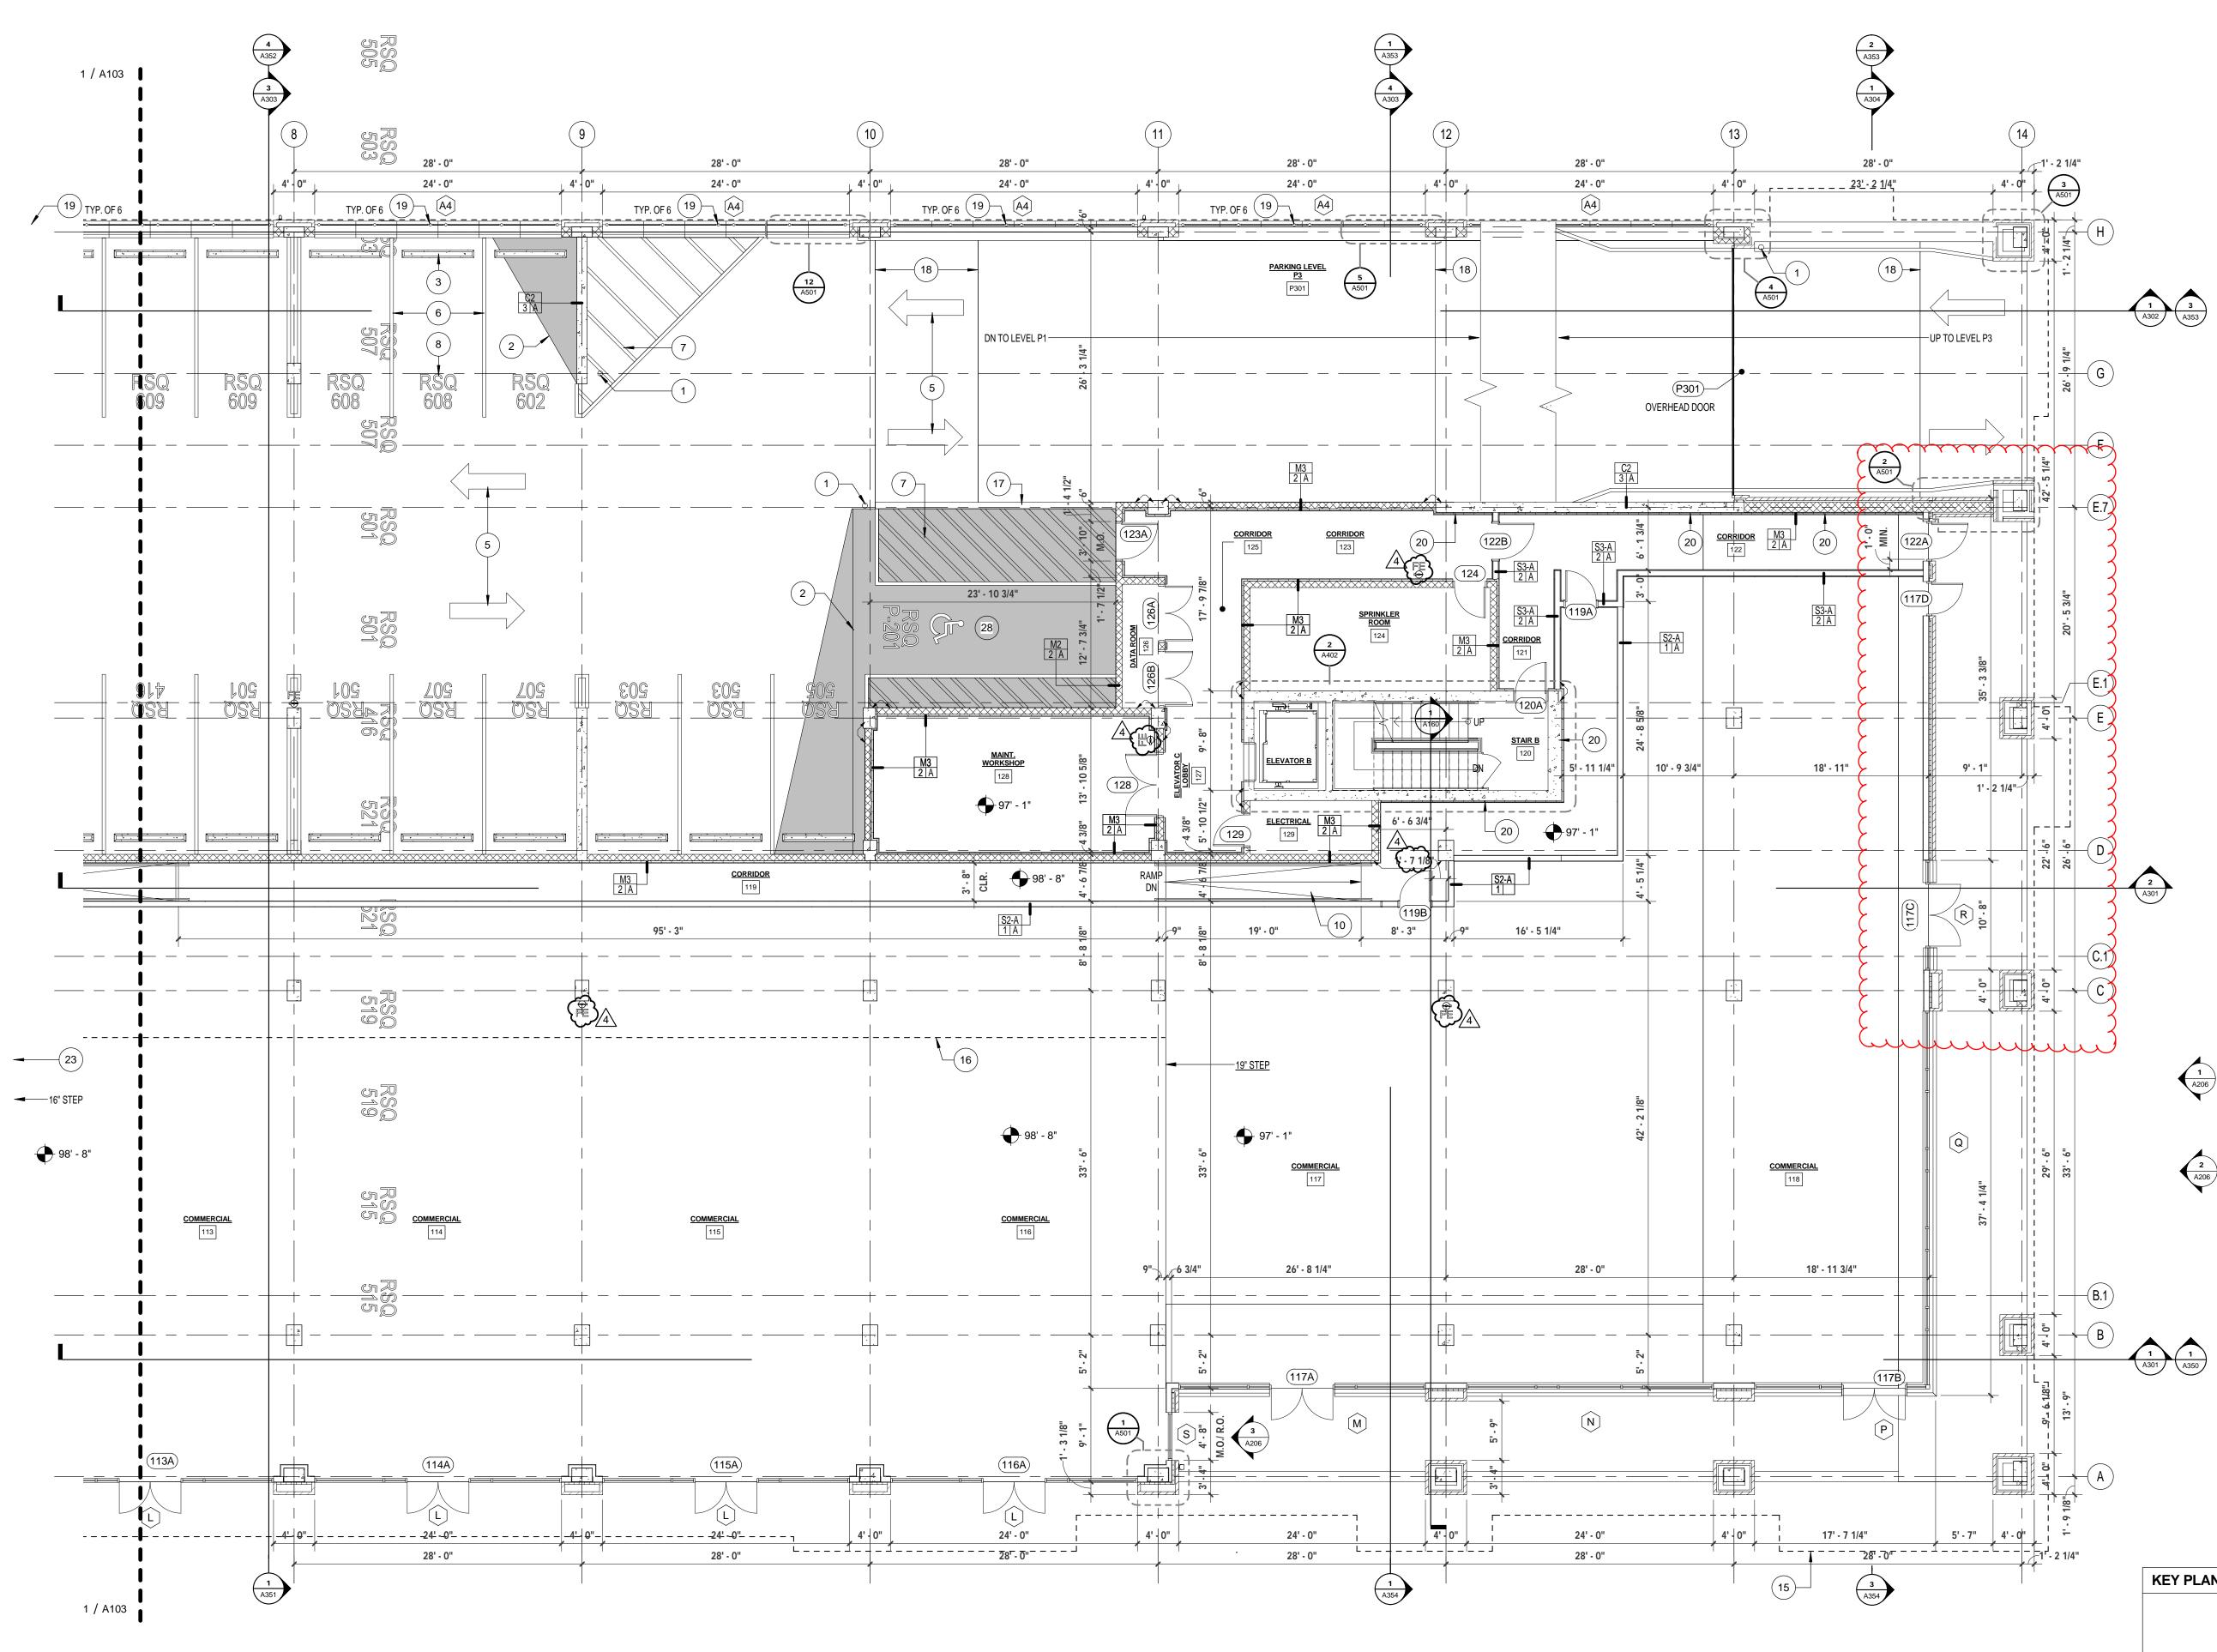

PARKING LEVEL 'P2' / FIRST FLOOR PLAN - EAST 1/8" = 1'-0"

**Previous Approval** 

# **KEYED NOTES - PARKING LEVEL**


- PAINTED STEEL BOLLARD
- CONCRETE OVERBUILD MAXIMUM SLOPE 1/4" = 1'-0" 3 PRECAST CONCRETE WHEEL STOP (REFER TO CIVIL
- PAVEMENT STOP BAR (REFER TO CIVIL DWG)
- 5 PAVEMENT ARROW (REFER TO CIVIL DWG)
- 6 PAVEMENT PARKING SPACE STRIPING (REFER TO CIVIL
- PAVEMENT DIAGONAL STRIPING (REFER TO CIVIL DWG) 3 PAVEMENT PARKING SPACE NUMBER (REFER TO FINISH PLANS)
- HANDICAP DECAL (REFER TO CIVIL DWG)
- 0 CAST IN PLACE CONCRETE RAMP MAX. SLOPE 1:12 WITH 1 1/2" DIAMETER HANDRAIL AND BRACKET SYSTEM (EACH SIDE)
- 1 TRASH CHUTE AND CHASE, ABOVE.
- 12 WASTE CONTAINER PROVIDED BY OWNER 13 RECESSED FRONT LOADING MAILBOX

9'-5" A.F.F.

- 4 NOT USED 15 HEAVY DASHED LINE INDICATES FACE OF BUILDING ABOVE, FOR REFERENCE ONLY
- 6 HEAVY DASHED LINE INDICATES OVERHANG OF PARKING LEVEL P3, FOR REFERENCE ONLY
- 7 LOW WALL 3'-6" ABOVE ADJACENT FLOOR LEVEL 18 SLOPE TRANSITION
- 9 STEEL POST (REFER TO STRUCTURAL DWG), AND WELDED MESH SCREEN (SEE ARCHITECTURAL DWG) 0 CONTINUE 2" GALVANIZED Z-FURRING WITH 2" XPS RIGID INSULATION TO DECK ABOVE.
- 1 EGRESS STAIR AND LANDING TO BE PROVIDED BY
- FUTURE TENANT. 22 6" CMU RETAINING WALL, REFER TO WALL SECTIONS AND STRUCTURAL DWG.
- 23 CONTRACTOR TO PROVIDE TEMPORARY RAILING AT
- FLOOR STEP. 24 MECHANICAL LOUVER, REFER TO MECHANICAL DWG
- 25 MINIMUM HEAD ROOM AT HANDICAP PARKING SPACE = 10'-2" A.F.F.
- 26 MINIMUM HEAD ROOM AT HANDICAP PARKING SPACE = 11'-0" A.F.F.
- 7 MINIMUM HEAD ROOM AT HANDICAP PARKING SPACE =
- 10'-10" A.F.F. 28 MINIMUM HEAD ROOM AT HANDICAP PARKING SPACE =

## **GENERAL NOTES - FLOOR PLAN**

- DIMENSIONS ARE TO FACE OF STUD OR FACE OF MASONRY / CONCRETE, UNLESS NOTED OTHERWISE CONTRACTOR SHALL VERIFY ALL CONDITIONS AND
- DIMENSIONS CONCERNING THE SCOPE OF WORK OF THIS PROJECT PRIOR TO COMMENCING WITH THE ASSOCIATED WORK. IN THE EVENT THE DIMENSIONS ARE IN QUESTION OR IF ANY DISCREPANCIES ARE ENCOUNTERED DURING CONSTRUCTION, THE
- CONTRACTOR SHALL NOTIFY THE ARCHITECT FOR CLARIFICATION PRIOR TO PROCEEDING WITH THE WORK FAILURE TO DO SO CONSTITUTES THE CONTRACTOR'S ACCEPTANCE OF THE WORK AS SHOWN. THE ROUGH OPENING OF A NEW DOOR GRAPHICALLY
- SHOWN IN THE CORNER OF A ROOM UNDIMENSIONED SHALL BE 0" OR 8" IN MASONRY WALLS (AS GRAPHICALLY INDICATED ON PLANS) OR 6" IN STUD FRAMED WALLS (AS GRAPHICALLY INDICATED ON PLANS), FROM THE INSIDE CORNER, UNLESS NOTED OR DIMENSIONED OTHERWISE
- THE ROUGH OPENING OF A NEW DOOR GRAPHICALLY SHOWN IN THE CENTER OF A WALL UNDIMENSIONED SHALL BE CENTERED ON WALL, UNLESS NOTED OR DIMENSIONED OTHERWISE.
- IN SPACES OPEN TO EXPOSED STRUCTURE ABOVE, PERIMETER WALLS OF SPACE SHALL EXTEND TO UNDERSIDE OF ROOF / FLOOR DECKING ABOVE.
- "CJ" INDICATES "CONTROL JOINT" & "EJ" INDICATES "EXPANSION JOINT". ALL WALLS, UNLESS NOTED OTHERWISE, ARE TO BE
- EXTENDED TO THE BOTTOM SIDE OF DECK (ROOF OR FLOOR) ABOVE AND SEALED TO SAME. ALL LOCATIONS WHERE BRICK VENEER BUTTS INTO CMU
- OR CAST STONE, A SOFT JOINT WITH BACKER ROD AND SEALANT SHALL BE PROVIDED (TYPICAL). O ALL EXPOSED STEEL SHALL BE FULLY AND COMPLETELY
- PAINTED WITH HIGH PERFORMANCE & FIRE RESISTIIVE COATINGS PRIOR TO INSTALLATION, UNO - REFER TO STRUCTURAL DRAWINGS & SPECIFICATIONS

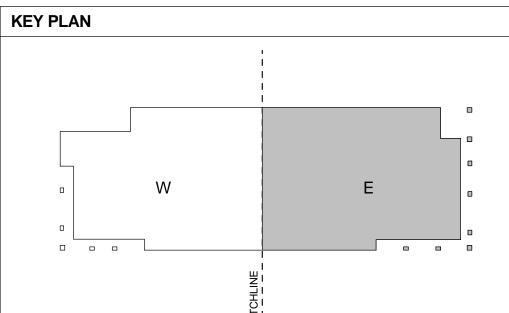



333 K

Ш Z

 $\triangleleft$ 

vation

**N**NO

sig

Ő

No.	Issued by	Date
1	PERMIT	01/30/17
2	ASI #02	04/24/2017
3	ASI #04	05/08/2017
4	ASI#14	03/23/2018
This drawing is the property of DESIGN INNOVATION ARCHITECTS,		

INC. and is not to be reproduced or copied in whole or in part without authorization from DESIGN INNOVATION ARCHITECTS, INC.. It is to be used for the project and site specifically identified herein and is not to be used on any other project. It is to be returned upon request. Do not scale drawings, written dimensions take precedence. All drawings and designs shown on these drawings are copyright © of DESIGN INNOVATION ARCHITECTS, INC.

Sheet Title

# PARKING 'P2' / **FIRST FLOOR** PLAN - EAST

Sheet Number

A104

01/30/17

oiect Number

14018

