

KNOXVILLE HISTORIC ZONING COMMISSION STAFF REPORT - CERTIFICATE OF APPROPRIATENESS APPLICATION

FILE NO.: 1-D-20-HZ

PROPERTY LOCATION: 1800 Jefferson Ave. /

Parcel ID 82 P H 009

DISTRICT: Edgewood-Park City H-1

MEETING DATE: 1/16/2020

APPLICANT: Kevin Dispensa Solar Alliance Southeast (Contractor)

LEVEL OF WORK: Level II. Major repair or replacement of materials or architectural elements

PROPERTY DESCRIPTION: Queen Anne, c. 1900

One and one-half story frame residence with aluminum siding. Hip roof with lower cross gables, asphalt shingle covering, two gabled dormers. Recessed portico. One over one double hung windows. Interior offset brick chimney. Brick foundation. Rectangular plan.

► DESCRIPTION OF WORK:

Installation of two solar arrays on the rear (south) elevation roof. One array will be located on primary hipped-roof massing of rear elevation, and feature eight individual panels (arranged in two adjoining rows of four). Second array will be located on the lower hipped-roof addition roof, and feature four adjoining panels. Panels will be 39" wide by 65" long and 1.6" thick and will be fixed to the roof via a metal rail system. Additional utility meter and disconnect will be attached to the west side of the building, adjacent to the existing meter. Solar panels will not be visible from the primary right-of-way.

► APPLICABLE DESIGN GUIDELINES:

Edgewood-Park City Design Guidelines, adopted by the Knoxville City Council on July 29, 1997.

5. Do not use satellite dishes, solar collectors, modern skylights, or inappropriate structures on roof planes that are visible form the street, or install them where they interfere with decorative roof elements.

Secretary of the Interior's Standards for Rehabilitation

- 9. New additions, exterior alterations, or related new construction shall not destroy historic materials that characterize the property. The new work shall be differentiated from the old and shall be compatible with the massing, size, scale, and architectural features to protect the historic integrity of the property and its environment.

 10. New additions and adjacent or related new construction shall be undertaken in such a manner that if removed
- in the future, the essential form and integrity of the historic property and its environment would be unimpaired.

COMMENTS:

N/A

STAFF FINDINGS:

- 1. The house is a contributing structure to the Edgewood-Park City H Overlay and National Register Historic District.
- 2. The proposed elevation for installation is the rear (south elevation). The house is situated at the center of the block and the rear elevation faces the alley and the adjoining block of houses fronting Woodbine Avenue. The elevation to receive solar panels is not visible from Jefferson Avenue and would be very minimally visible from



KNOXVILLE HISTORIC ZONING COMMISSION STAFF REPORT - CERTIFICATE OF APPROPRIATENESS APPLICATION

PROPERTY LOCATION: 1800 Jefferson Ave. / Parcel ID 82 P H 009

FILE NO.: 1-D-20-HZ

DISTRICT: Edgewood-Park City H-1

Woodbine Avenue.

- 3. The solar panels and racking will be mounted parallel to the roof slope and will project approximately two inches high above the roof, including the racking system. The necessary utility meter and disconnect will be installed on the west elevation of the building, next to the existing electrical meter, on a non-character-defining section of the house.
- 4. No historic roofing materials or features will be altered or removed for installation of the solar panels or associated equipment.

► STAFF RECOMMENDATION:

Staff recommends approval of the work as proposed.






APPLICATION FOR CERTIFICATE OF APPROPRIATENESS



1800 Jefferson Ave. 37917

Edgewood-Park City H-1

Original Print Date: 1/6/2020 Knoxville/Knox County Planning -- Historic Zoning Commission

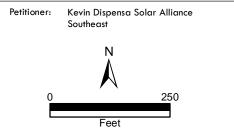



Applicant Signature

	DESIGN REVIEW I	KEQUES	ı	
	DOWNTOWN DESIGN (DK)			
Planning	HISTORIC ZONING (H)			
KNOXVILLE I KNOX COUNTY	INFILL HOUSING (IH)			
KEVIN DISPENSA				
Applicant				
12/17/19	1/16/20		1-D-20-F	IZ
Date Filed	Meeting Date (if applicable)	ANT	File Numbe	r(s)
CORRESPONDENCE				
	oplication should be directed to the appropriate of		ed below.	
KEVIN DISPENSA	gineer	ct Ar alliance sou	JTHEAST	
Name	Com			
3709 MARTIN MILL PIKE	KNO	XVILLE	TN	37920
Adáress	City		State	Zip
847-305-9936	KDISPENSA@SOLARALLIANCE.	сом		
Phone	Email			******************
CURRENT PROPERTY I	NFO			
LYNNE RANDAZZO	1800 JEFFERSON AVE		33	36-682-6239
Owner Name (if different from applic	cant) Owner Address		Ov	vner Phone
L800 JEFFERSON AVE		082PH009		
Property Address	**************************************	Parcel ID		
EDGEWOOD		H-1		
Neighborhood	11 to 12	Zoning		
AUTHORIZATION				
Lindson Crownott	Lindson Crock	011	12	16/10
Staff Signature	Lind Say Crock Please Print		Da	/16/19 te
¥	WM.			
Don't Din	KEVIN DISPENSA		. 12	2/16/19

Date

Please Print

REQUEST

DOWNTOWN DESIGN	Level 1: Signs Alteration of an existing building/structure Level 2: Addition to an existing building/structure Level 3: Construction of new building/structure Site design, parking, plase required Downtown Design attachment for more details. Brief description of work:	azas, landscape	
HISTORIC ZONING	Level 1: Signs Routine repair of siding, windows, roof, or other features, Level 2: Major repair, removal, or replacement of architectural elements or malevel 3: Construction of a new primary building Level 4: Relocation of a contributing structure Demolition of a contribution	aterials Additions and acce ting structure DULES ON THE REAR (FACING THE	essory structures E ALLEY) OF THE STRUCTURE.
INFILL HOUSING	Level 1: Driveways, parking pads, access point, garages or similar facilities Level 2: Additions visible from the primary street Changes to porches visible level 3: New primary structure Site built Modular Multi-Sectional See required Infill Housing attachment for more details. Brief description of work:		
STAFF USE ONLY	ATTACHMENTS Downtown Design Checklist Historic Zoning Design Checklist Infill Housing Design Checklist ADDITIONAL REQUIREMENTS Property Owners / Option Holders Level 1: \$50 • Level 2: \$100 • Level 3: \$250 • Level 4: \$500	FEE 1: FEE 2: FEE 3:	TOTAL:




Historic Zoning Review Request

for 1800 Jefferson Ave. Knoxville, TN 37917

LEVEL 2 Additions and Accessory Structures

Review Request Form	1
Dimensioned Site Plan of Property	3
Dimensioned Front Elevation	
Dimensioned Rear Elevation	.5
Heleine 60-HBLK Solar Module Data Sheet	6
Ironridge Flushmount System Datasheet	8
Ironridge Sloped Roof Mount System Datasheet	10

Center Line Jefferson Ave.

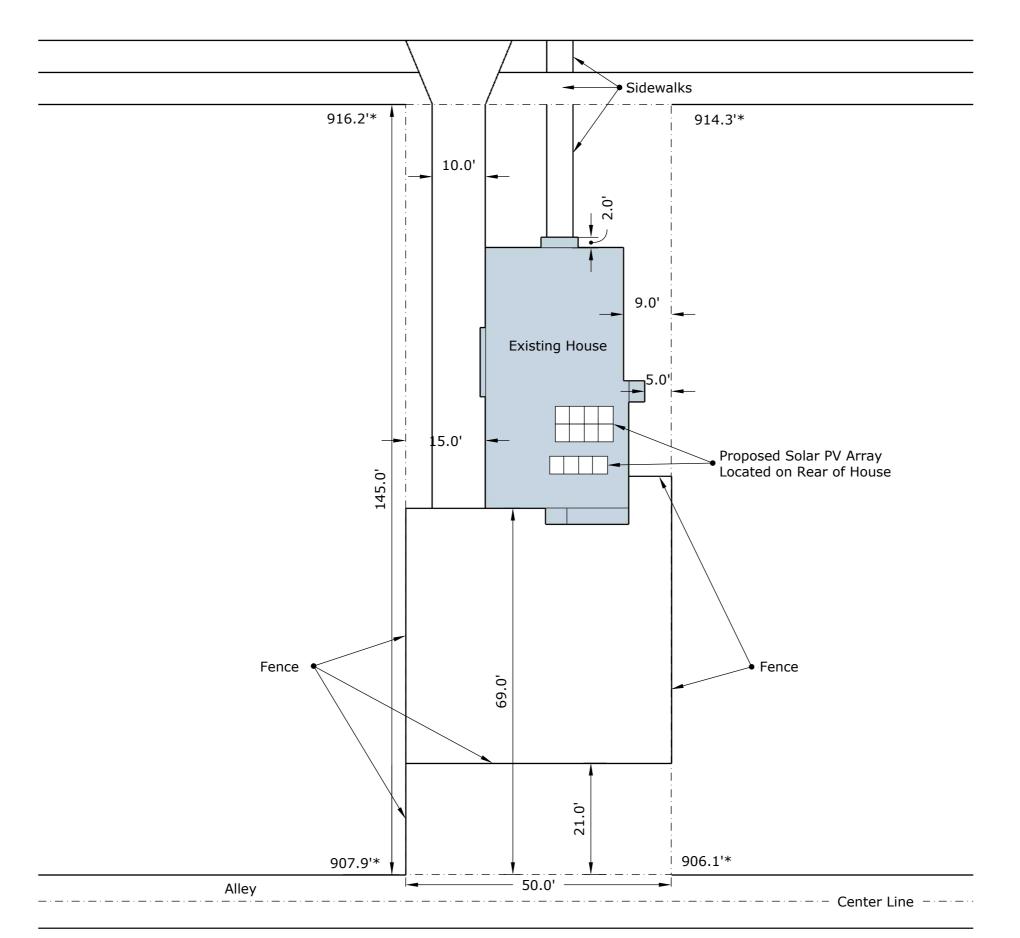

Ward Number: 6 Lot Number: 082PH009



3709 Martin Mill Pike Knoxville, TN 37920

Ryan Dunaway RDunaway@SolarAlliance.com

(865) 309-4674

Project Info Client: Lynne Randazzo 1800 Jefferson Ave. Knoxville, TN 37917 (336) 682-6239

3.4 kW Solar PV System Residential Grid tied Roof Mount


Drawing Info Title: Randazzo Historic Plot Plan

Date:

December 17, 2019

Revision: 1

Front elevation will NOT be affected

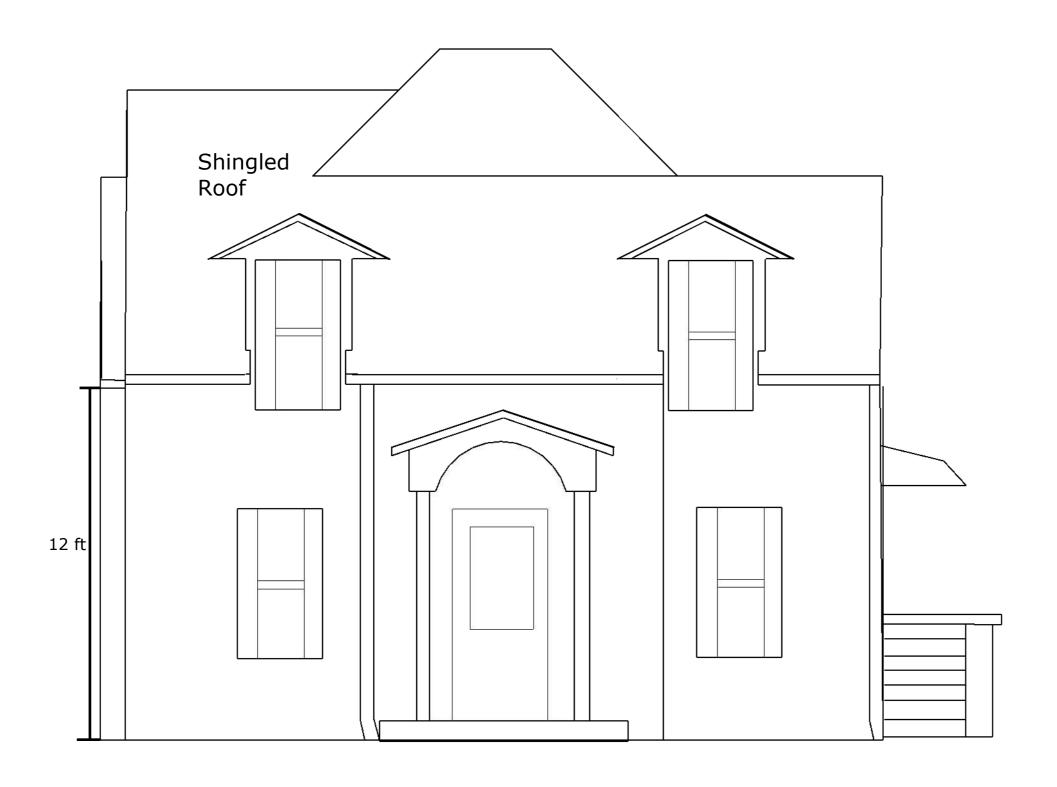

FRONT ELEVATION



3709 Martin Mill Pike Knoxville, TN 37920

Ryan Dunaway RDunaway@SolarAlliance.com

(865) 309-4674

Project Info Client: Lynne Randazzo 1800 Jefferson Ave. Knoxville, TN 37917 (336) 682-6239


3.4 kW Solar PV System Residential Grid tied Roof Mount

Drawing Info Title: Randazzo Front Elevation

Date:

December 17, 2019

Revision: 1

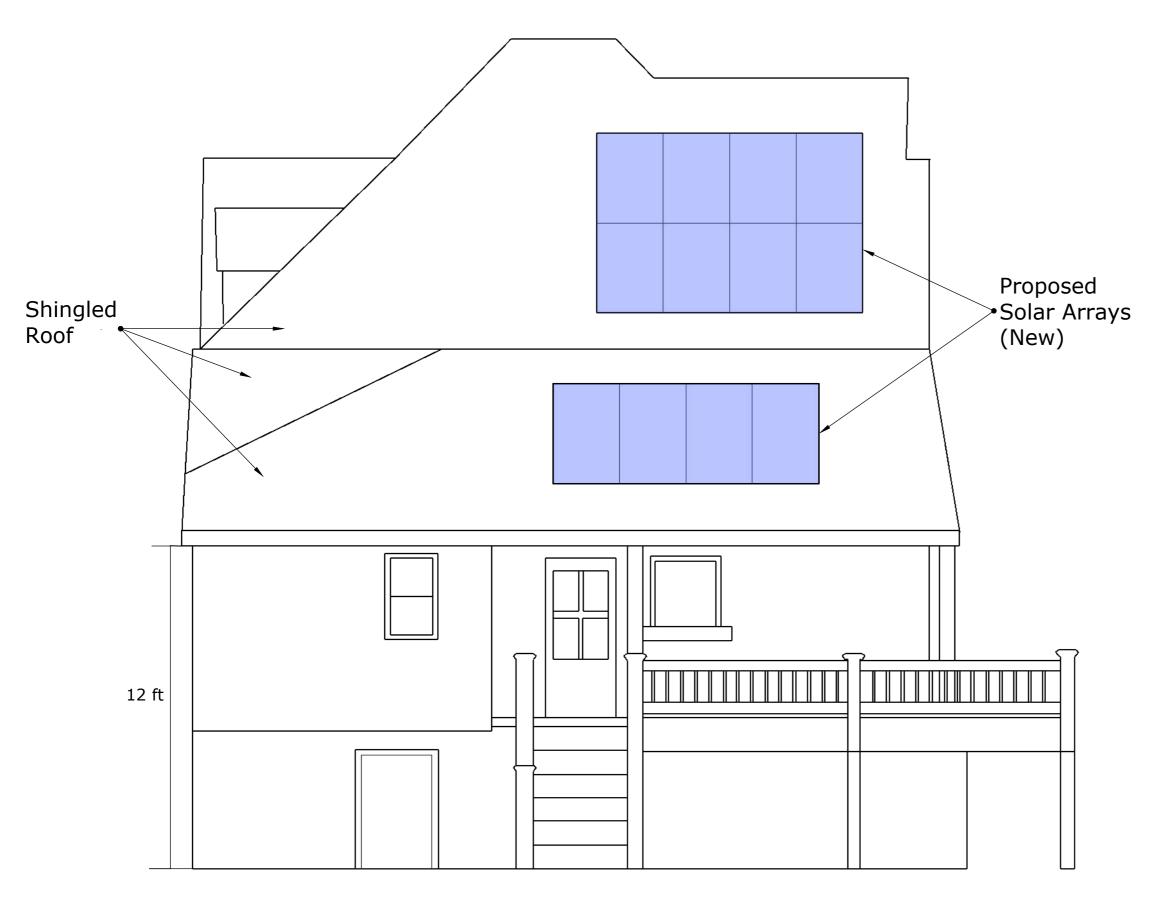





3709 Martin Mill Pike Knoxville, TN 37920

Ryan Dunaway RDunaway@SolarAlliance.com

(865) 309-4674


Project Info Client: Lynne Randazzo 1800 Jefferson Ave. Knoxville, TN 37917 (336) 682-6239

3.4 kW Solar PV System Residential Grid tied Roof Mount

Drawing Info Title: Randazzo Rear Elevation

Date: December 17, 2019


Revision: 1

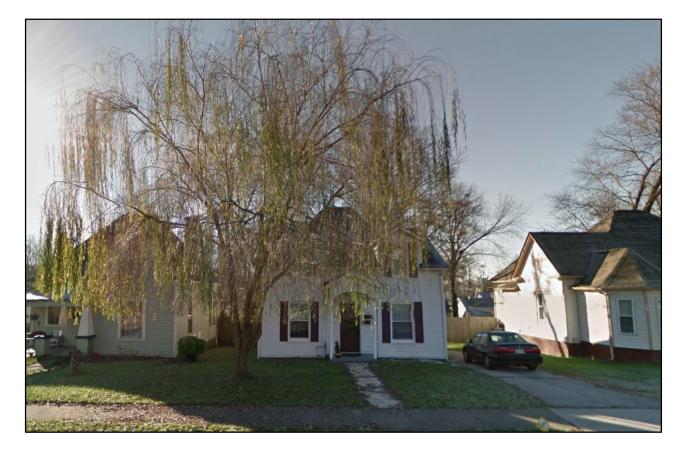



Façade, facing south

Rear elevation to receive solar panels, facing north

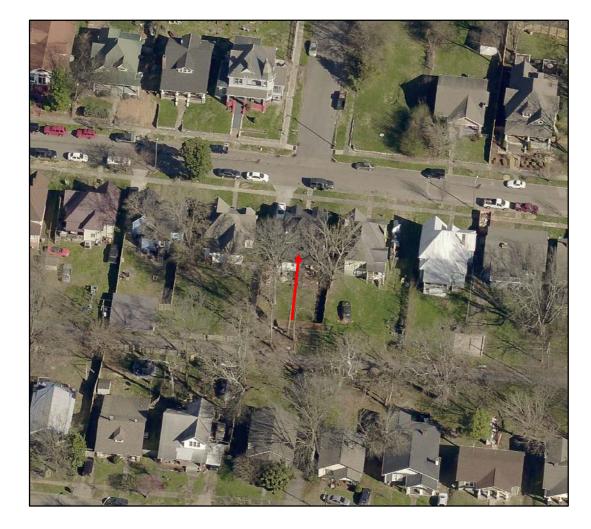



2018 aerial of property from Pictometry, facing north

2018 aerial of property from Pictometry, facing south





2018 aerial of property from Pictometry, facing east

2018 aerial of property from Pictometry, facing west



60-CELL MONOCRYSTALLINE MODULE

300 Wp

MAX POWER OUPUT

18.6%

MAX EFFICIENCY

10 YEAR

PRODUCT WARRANTY

25 YEAR

LINEAR PERFORMANCE GUARANTEE

HELIENE INC. IS A PREMIER SOLAR MODULE MANUFACTURER, SERVICING THE GROWING SOLAR ENERGY MARKETS OF NORTH AMERICA.

COMBINING PROVEN EUROPEAN TECHNOLOGY WITH NORTH AMERICAN INGENUITY ALLOWS HELIENE TO MAKE A REAL COMMITMENT IN PROVIDING SMARTER ENERGY CHOICES FOR THE FUTURE.

> Heliene Inc. www.heliene.com







H-BLACK INTEGRATION - BLACK FRAME & BACKSHEET



PERFECT FOR HIGH VISIBILITY APPLICATIONS




MANUFACTURED ACCORDING TO INTERNATIONAL QUALITY SYSTEM STANDARDS: ISO9001



GUARANTEED POSITIVE POWER SORTING: [-0: +4.99 WP]


LINEAR PERFORMANCE GUARANTEE

10 YEAR WORKMANSHIP WARRANTY • 25 YEAR LINEAR PERFORMANCE GUARANTEE

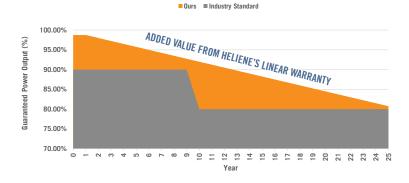




DIMENSIONS FOR HELIENE GOM SERIES MODULES

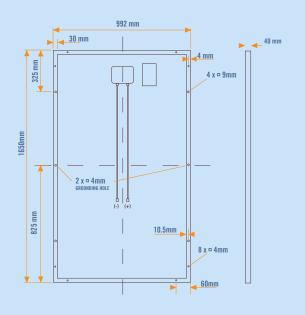

I-V CURVE FOR HELIENE 60M SERIES

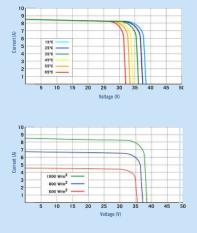

CERTIFICATIONS









ELECTRICAL DATA (STC) P_{mpp} (W) Peak Rated Power 300 295 290 285 Maximum Power Voltage V_{mpp} (V) 33.139 32.838 32.537 32.236 9.127 **Maximum Power Current** I_{mpp} (A) 9.058 8.989 8.920 Open Circuit Voltage V_{oc} (V) 39.830 39.679 39.528 39.377 **Short Circuit Current** Isc (A) 9.590 9.507 9.424 9.341

18.6

18.3

[-0, +4.99] Wp

18.0

17.7

STC - Standard Test Conditions: Irradiation 1000 W/m2 - Air mass AM 1.5 - Cell temperature 25 $^{\circ}$ C

* Calculated using maximum power based on full positive output tolerance [-0, +4.99] Wp

Eff (%)

MECHANICAL DATA

Module Efficiency *

Power Output Tolerance

Dimensions (L x W x D)	1650 x 992 x 40 mm (65 x 39 x 1.6 inch)	
Weight*	20 kg (43.9 lbs)	
Output Cables	1.1 m (43.3 inch) symmetrical cables with MC4 type connectors	
Junction Box	IP-67 rated with bypass diodes	
Frame	Double webbed 15 micron anodized aluminum alloy	
Front Glass	Low-iron content, high-transmission PV solar glass	
Solar Cells	60 Monocrystalline cells (156 x 156 mm)	

^{*} Calculated using 3.2mm PV glass, if 4mm profile is requested weight load will vary

CERTIFICATIONS

UL Listed	ULC/ORD-C1703-1 , UL1703, UL1703 Fire Classification Type 1
IEC Listed	IEC 61215, IEC 61730

All Heliene modules are certified under the California Energy Commision (CEC) Listing Report

TEMPERATURE RATINGS

Nominal Operating Cell Temperature (NOCT)	+45°C (±2°C)
Temperature Coefficient of P_{\max}	-0.39%/°C
Temperature Coefficient of $V_{\mbox{\tiny oc}}$	-0.31%/°C
Temperature Coefficient of I _{sc}	0.045%/°C

MAXIMIM RATINGS

Operational Temperature	-40°C - +85°C	
Max System Voltage	1500V (UL / IEC)	
Max Series Fuse Rating	15 A	

WARRANTY

10 Year Manufacturer's Workmanship Warranty
25 Year Linear Power Guarantee

(Refer to product warranty page for details)

PACKAGING CONFIGURATION

Modules per box:	25 pieces
Modules per 53' trailer:	750 pieces















Flush Mount System



Built for solar's toughest roofs.

IronRidge builds the strongest mounting system for pitched roofs in solar. Our components have been tested to the limit and proven in extreme environments, including Florida's high-velocity hurricane zones.

Our rigorous approach has led to unique structural features, such as curved rails and reinforced flashings, and is also why our products are fully certified, code compliant and backed by a 25-year warranty.



Strength Tested

All components evaluated for superior structural performance.



PE Certified

Pre-stamped engineering letters available in most states.



Class A Fire Rating

Certified to maintain the fire resistance rating of the existing roof.



Design Assistant

Online software makes it simple to create, share, and price projects.



UL 2703 Listed System

Entire system and components meet newest effective UL 2703 standard.



25-Year Warranty

Products guaranteed to be free of impairing defects.

XR Rails (

XR10 Rail



A low-profile mounting rail for regions with light snow.

- · 6' spanning capability
- Moderate load capability
- · Clear and black finish

XR100 Rail



The ultimate residential solar mounting rail.

- 8' spanning capability
- · Heavy load capability
- · Clear and black finish

XR1000 Rail



A heavyweight mounting rail for commercial projects.

- 12' spanning capability
- · Extreme load capability
- · Clear anodized finish

Bonded Splices



All rails use internal splices for seamless connections.

- Self-drilling screws
- · Varying versions for rails
- · Forms secure bonding

Clamps & Grounding

UFOs



Universal Fastening Objects bond modules to rails.

- Fully assembled & lubed
- · Single, universal size
- · Clear and black finish

Stopper Sleeves



Snap onto the UFO to turn into a bonded end clamp.

- Bonds modules to rails
- · Sized to match modules
- · Clear and black finish

CAMO



Bond modules to rails while staying completely hidden.

- Universal end-cam clamp
- · Tool-less installation
- · Fully assembled

Bonding Hardware



Bond and attach XR Rails to roof attachments.

- T & Square Bolt options
- Nut uses 7/16" socket
- · Assembled and lubricated

Attachments

FlashFoot2



Flash and mount XR Rails with superior waterproofing.

- Twist-on Cap eases install
- · Wind-driven rain tested
- Mill and black finish

Conduit Mount



Flash and mount conduit, strut, or junction boxes.

- Twist-on Cap eases install
- Wind-driven rain tested
- Secures 3/4" or 1" conduit

Knockout Tile



Replace tiles and ensure superior waterproofing.

- · Flat, S, & W tile profiles
- Form-fit compression seal
- · Single-lag universal base

All Tile Hook



Mount on tile roofs with a simple, adjustable hook.

- · Works on flat, S, & W tiles
- Single-socket installation
- Optional deck flashing

Resources



Design Assistant

Go from rough layout to fully engineered system. For free.


Go to IronRidge.com/design



Endorsed by FL Building Commission

Flush Mount is the first mounting system to receive Florida Product approval for 2017 Florida Building Code compliance.

Learn More at bit.ly/floridacert

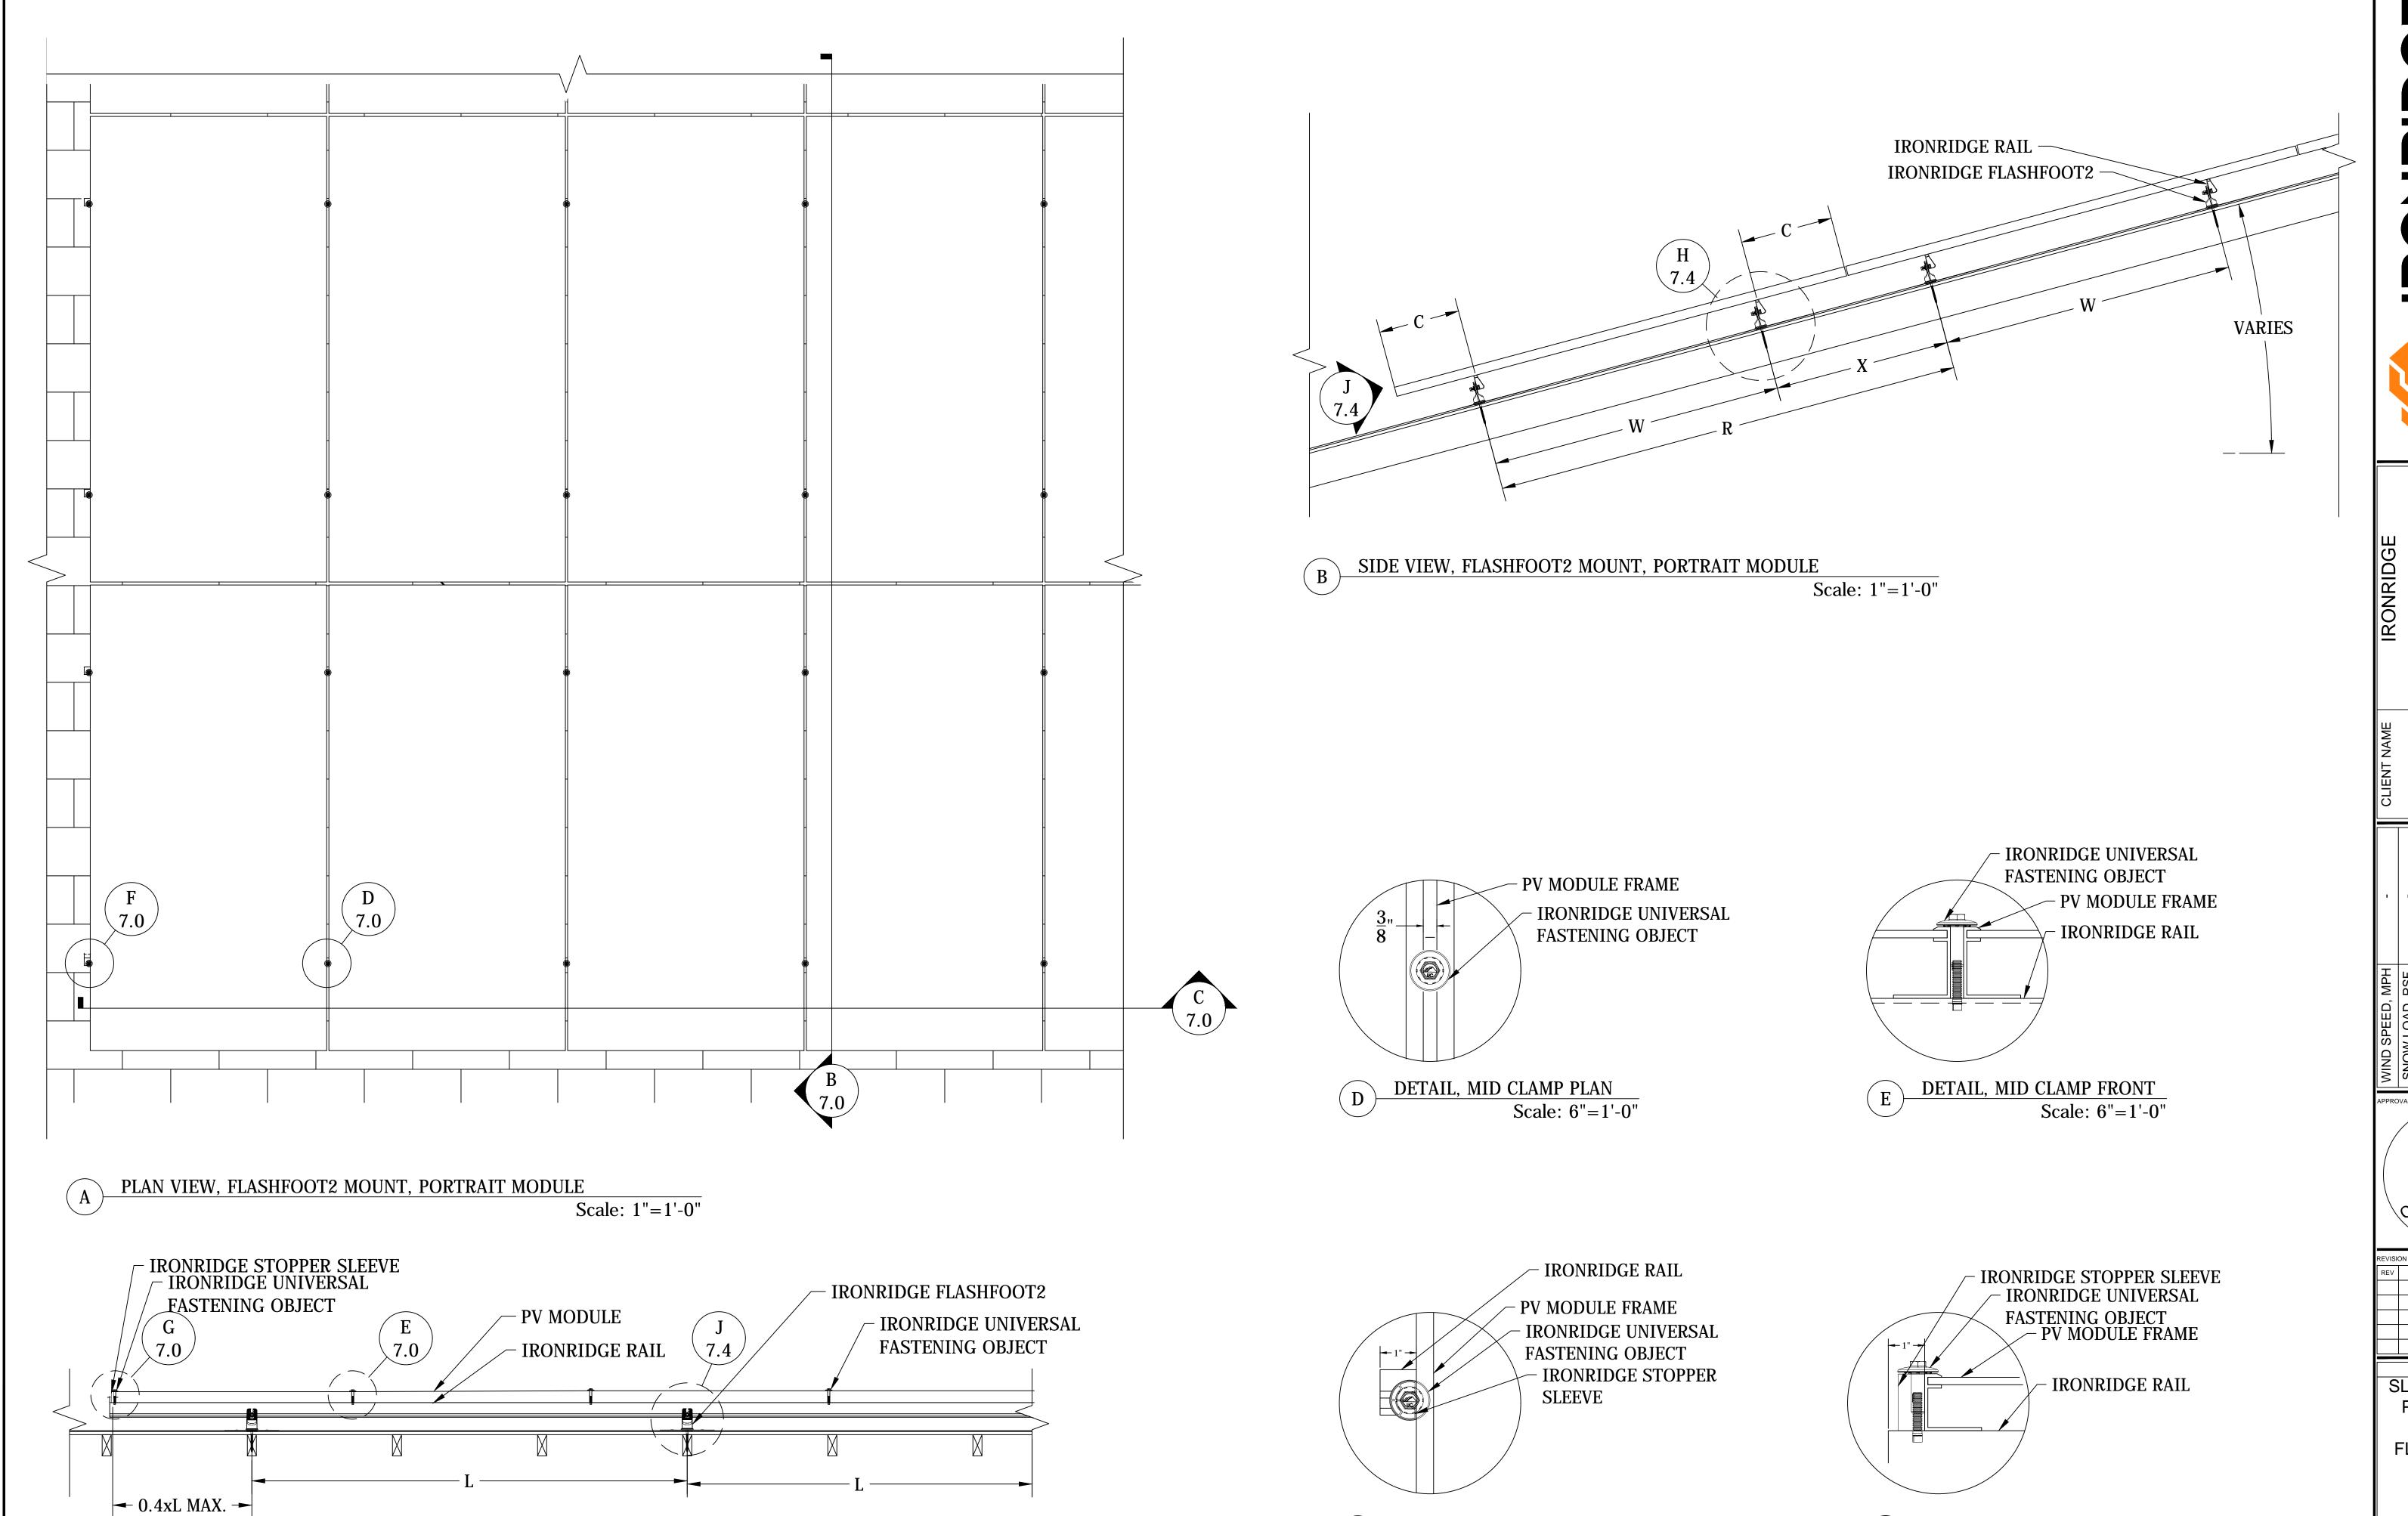

FRONT VIEW, FLASHFOOT2 MOUNT, PORTRAIT MODULE

Scale: 1"=1'-0"

DETAIL, END CLAMP (UFO) PLAN

Scale: 6"=1'-0"

1495 ZEPHYR AVE, HAYWARD, CA 94544
800.227.9523 IRONRIDGE.COM

UNT SYSTEM

CONSTRUCTION

SHEET NAME
SLOPED ROOF


DESCRIPTION

SLOPED ROOF
PV SYSTEM
DETAILS:
FLASHFOOT2
(UFO)

JOB NO. 3.1 SR
ISSUE DATE DEC 2018
SHEET NO. IR 7.0
SHEET SIZE 24X36

DETAIL, END CLAMP (UFO) FRONT

Scale: 6"=1'-0"

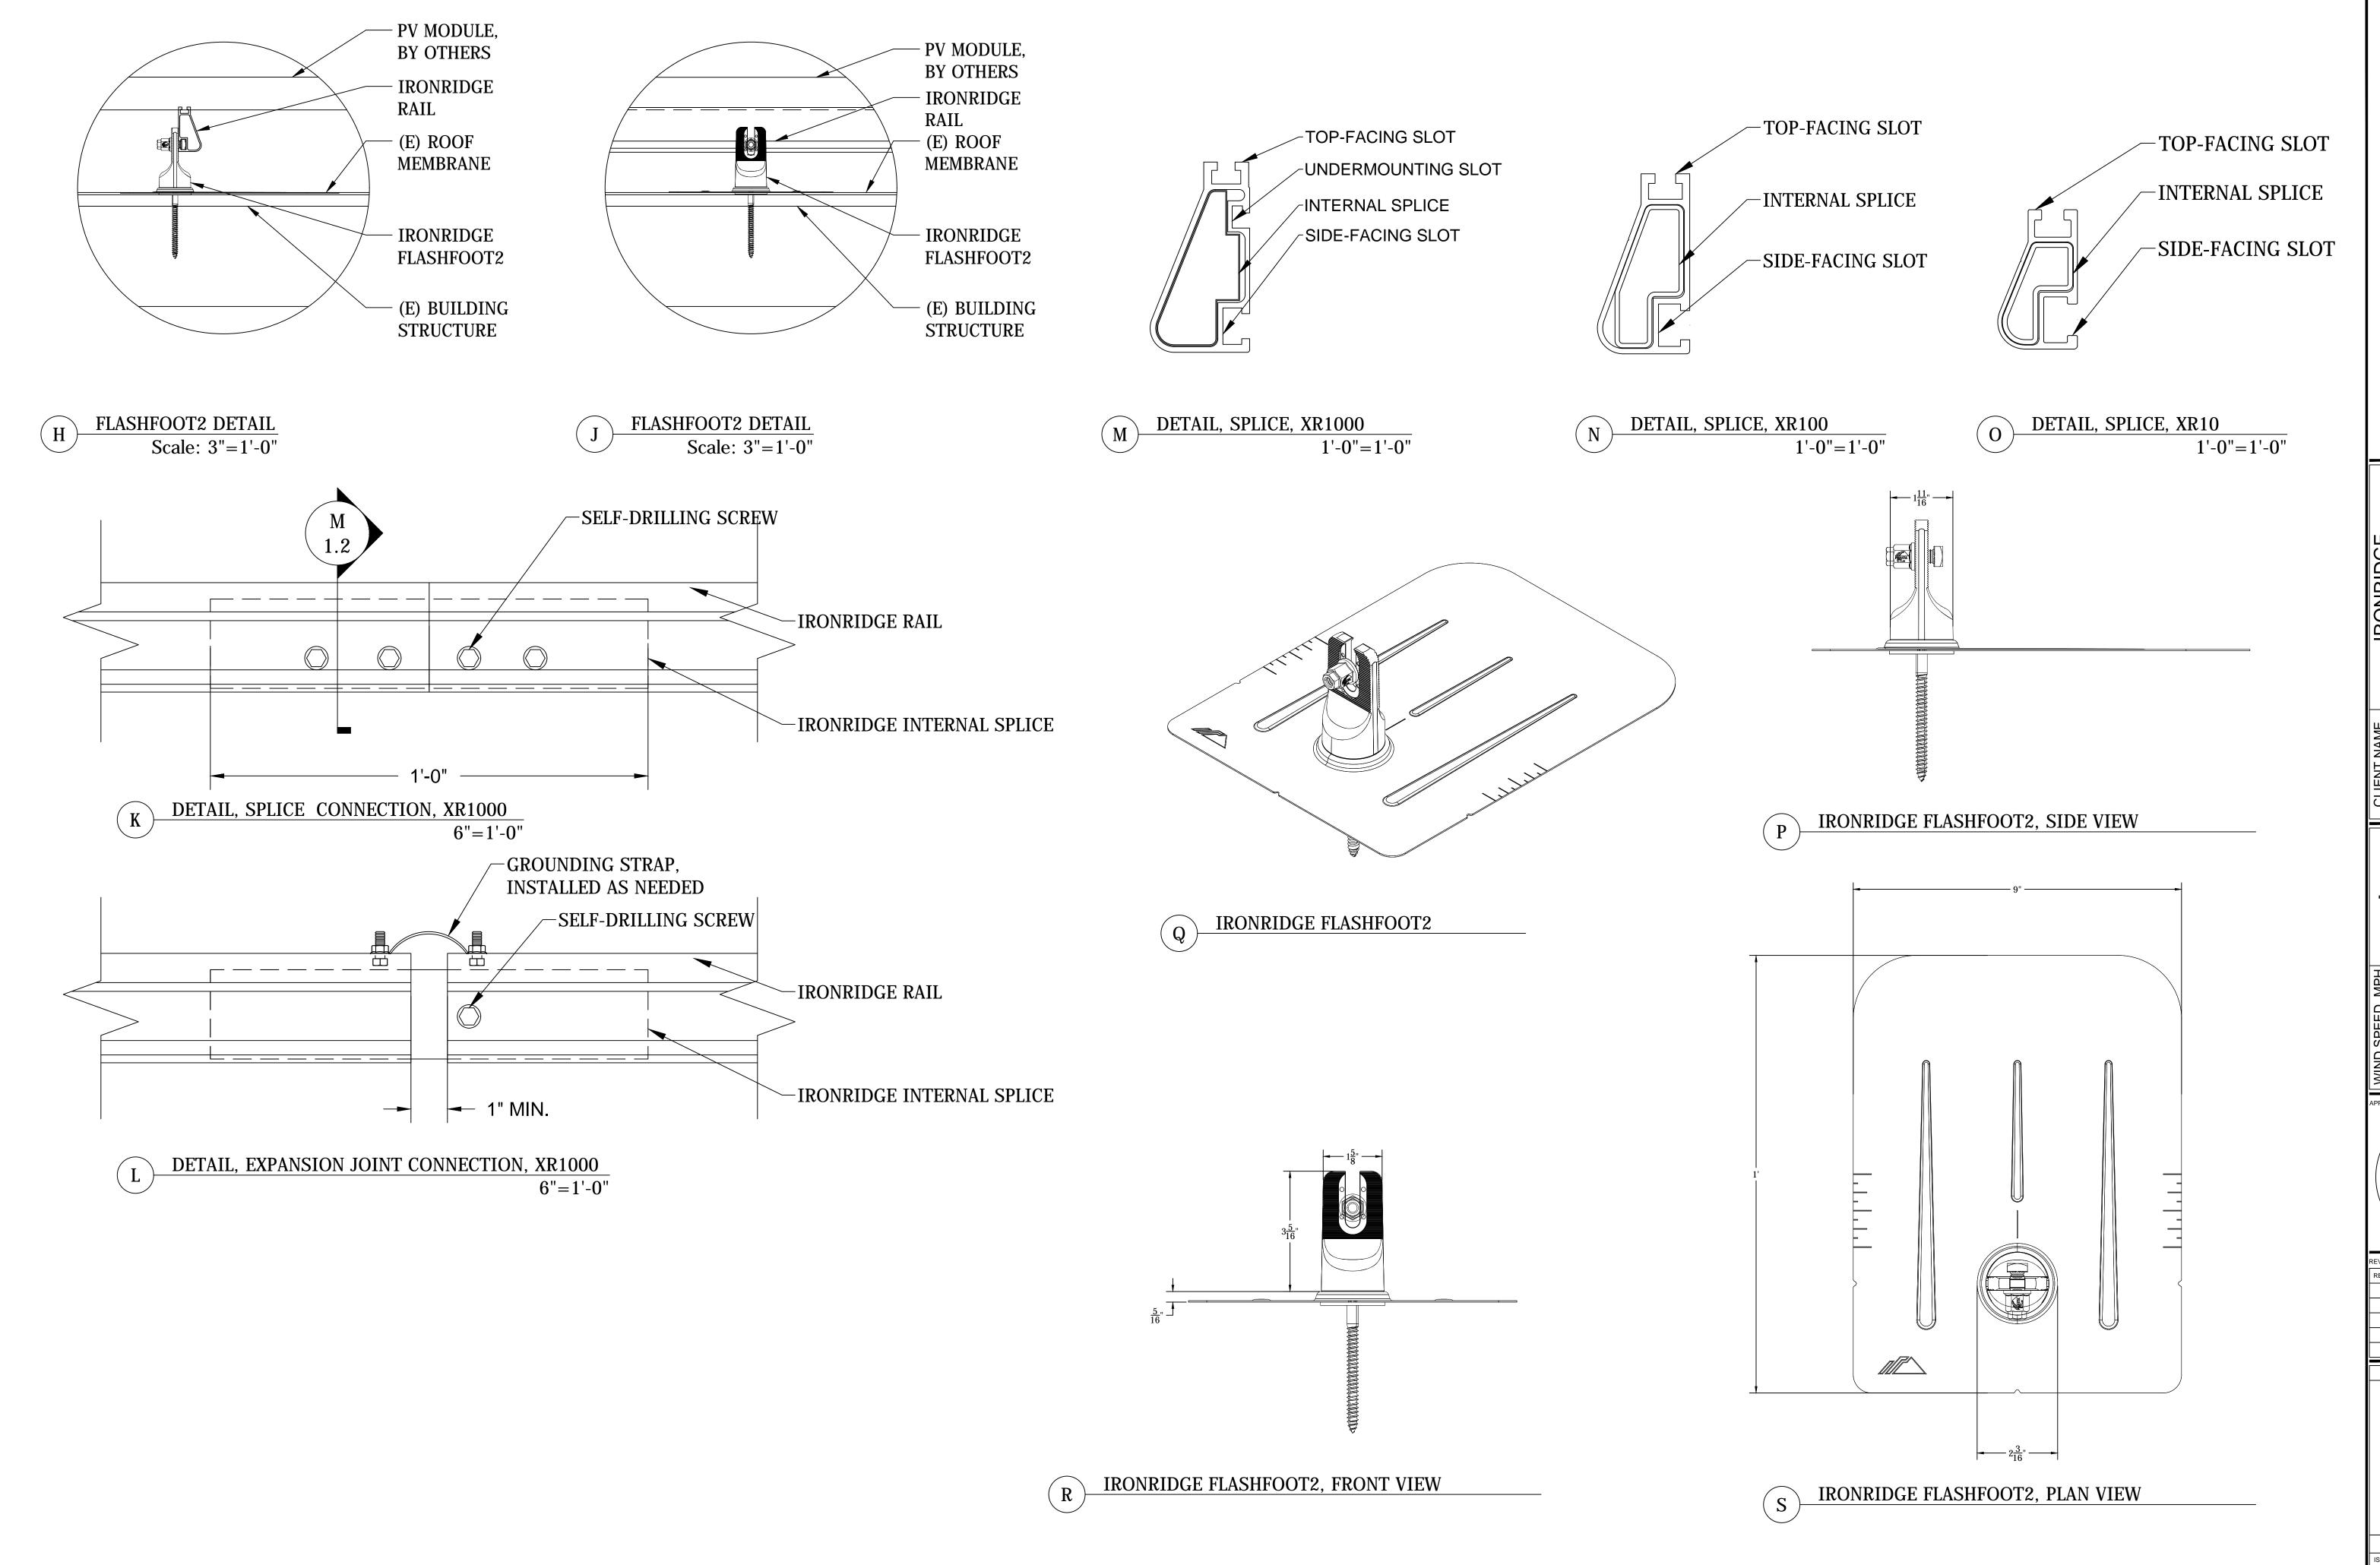

1495 ZEPHYR AVE, HAYWARD, CA 94544
800.227.9523 IRONRIDGE.COM

DUNT SYSTEM

1495 Z

ROVAL STATUS

ROVAL STATUS

ROVAL STATUS

ROVAL STATUS

DESCRIPTION DAT

SLOPED ROOF
PV SYSTEM
DETAILS:
FLASHFOOT2

JOB NO. 3.1 SR
ISSUE DATE DEC 2018
SHEET NO. IR 7.4
SHEET SIZE 24X36